


LABORATORY EQUIPMENT SCHEDULE

ITEM	QUANTITY	EQUIP. DESIGN	QTY	W.H.	QTY	CHIEF	STEAM	WASTE	REMARKS
B-1	120	BIOLOGY TABLE	1/2"	1/2"	1/2"	1/2"	1/2"	1/2"	DISMOUNTED EXTRA TABLE, BY D.S. STEWART HALL - MOVE - RECONNECT
B-2	120	BIOLOGY TABLE	1/2"	1/2"	1/2"	1/2"	1/2"	1/2"	DISMOUNTED EXTRA TABLE, BY D.S. STEWART HALL - MOVE - RECONNECT
B-3	120	BIOLOGY TABLE	1/2"	1/2"	1/2"	1/2"	1/2"	1/2"	DISMOUNTED EXTRA TABLE, BY D.S. STEWART HALL - MOVE - RECONNECT
B-4	120	BIOLOGY TABLE	1/2"	1/2"	1/2"	1/2"	1/2"	1/2"	DISMOUNTED EXTRA TABLE, BY D.S. STEWART HALL - MOVE - RECONNECT
B-5	120	BIOLOGY TABLE	1/2"	1/2"	1/2"	1/2"	1/2"	1/2"	DISMOUNTED EXTRA TABLE, BY D.S. STEWART HALL - MOVE - RECONNECT
B-6	120	BIOLOGY TABLE	1/2"	1/2"	1/2"	1/2"	1/2"	1/2"	DISMOUNTED EXTRA TABLE, BY D.S. STEWART HALL - MOVE - RECONNECT
B-7	120	BIOLOGY TABLE	1/2"	1/2"	1/2"	1/2"	1/2"	1/2"	DISMOUNTED EXTRA TABLE, BY D.S. STEWART HALL - MOVE - RECONNECT
B-8	120	BIOLOGY TABLE	1/2"	1/2"	1/2"	1/2"	1/2"	1/2"	DISMOUNTED EXTRA TABLE, BY D.S. STEWART HALL - MOVE - RECONNECT
B-9	120	BIOLOGY TABLE	1/2"	1/2"	1/2"	1/2"	1/2"	1/2"	DISMOUNTED EXTRA TABLE, BY D.S. STEWART HALL - MOVE - RECONNECT
B-10	120	BIOLOGY TABLE	1/2"	1/2"	1/2"	1/2"	1/2"	1/2"	DISMOUNTED EXTRA TABLE, BY D.S. STEWART HALL - MOVE - RECONNECT
B-11	120	BIOLOGY TABLE	1/2"	1/2"	1/2"	1/2"	1/2"	1/2"	DISMOUNTED EXTRA TABLE, BY D.S. STEWART HALL - MOVE - RECONNECT
B-12	120	BIOLOGY TABLE	1/2"	1/2"	1/2"	1/2"	1/2"	1/2"	DISMOUNTED EXTRA TABLE, BY D.S. STEWART HALL - MOVE - RECONNECT
B-13	120	BIOLOGY TABLE	1/2"	1/2"	1/2"	1/2"	1/2"	1/2"	DISMOUNTED EXTRA TABLE, BY D.S. STEWART HALL - MOVE - RECONNECT
B-14	120	BIOLOGY TABLE	1/2"	1/2"	1/2"	1/2"	1/2"	1/2"	DISMOUNTED EXTRA TABLE, BY D.S. STEWART HALL - MOVE - RECONNECT
B-15	120	BIOLOGY TABLE	1/2"	1/2"	1/2"	1/2"	1/2"	1/2"	DISMOUNTED EXTRA TABLE, BY D.S. STEWART HALL - MOVE - RECONNECT
B-16	120	BIOLOGY TABLE	1/2"	1/2"	1/2"	1/2"	1/2"	1/2"	DISMOUNTED EXTRA TABLE, BY D.S. STEWART HALL - MOVE - RECONNECT
B-17	120	BIOLOGY TABLE	1/2"	1/2"	1/2"	1/2"	1/2"	1/2"	DISMOUNTED EXTRA TABLE, BY D.S. STEWART HALL - MOVE - RECONNECT
B-18	120	BIOLOGY TABLE	1/2"	1/2"	1/2"	1/2"	1/2"	1/2"	DISMOUNTED EXTRA TABLE, BY D.S. STEWART HALL - MOVE - RECONNECT
B-19	120	BIOLOGY TABLE	1/2"	1/2"	1/2"	1/2"	1/2"	1/2"	DISMOUNTED EXTRA TABLE, BY D.S. STEWART HALL - MOVE - RECONNECT
B-20	120	BIOLOGY TABLE	1/2"	1/2"	1/2"	1/2"	1/2"	1/2"	DISMOUNTED EXTRA TABLE, BY D.S. STEWART HALL - MOVE - RECONNECT
B-21	120	BIOLOGY TABLE	1/2"	1/2"	1/2"	1/2"	1/2"	1/2"	DISMOUNTED EXTRA TABLE, BY D.S. STEWART HALL - MOVE - RECONNECT
B-22	120	BIOLOGY TABLE	1/2"	1/2"	1/2"	1/2"	1/2"	1/2"	DISMOUNTED EXTRA TABLE, BY D.S. STEWART HALL - MOVE - RECONNECT
B-23	120	BIOLOGY TABLE	1/2"	1/2"	1/2"	1/2"	1/2"	1/2"	DISMOUNTED EXTRA TABLE, BY D.S. STEWART HALL - MOVE - RECONNECT
B-24	120	BIOLOGY TABLE	1/2"	1/2"	1/2"	1/2"	1/2"	1/2"	DISMOUNTED EXTRA TABLE, BY D.S. STEWART HALL - MOVE - RECONNECT
B-25	120	BIOLOGY TABLE	1/2"	1/2"	1/2"	1/2"	1/2"	1/2"	DISMOUNTED EXTRA TABLE, BY D.S. STEWART HALL - MOVE - RECONNECT
B-26	120	BIOLOGY TABLE	1/2"	1/2"	1/2"	1/2"	1/2"	1/2"	DISMOUNTED EXTRA TABLE, BY D.S. STEWART HALL - MOVE - RECONNECT
B-27	120	BIOLOGY TABLE	1/2"	1/2"	1/2"	1/2"	1/2"	1/2"	DISMOUNTED EXTRA TABLE, BY D.S. STEWART HALL - MOVE - RECONNECT
B-28	120	BIOLOGY TABLE	1/2"	1/2"	1/2"	1/2"	1/2"	1/2"	DISMOUNTED EXTRA TABLE, BY D.S. STEWART HALL - MOVE - RECONNECT
B-29	120	BIOLOGY TABLE	1/2"	1/2"	1/2"	1/2"	1/2"	1/2"	DISMOUNTED EXTRA TABLE, BY D.S. STEWART HALL - MOVE - RECONNECT
B-30	120	BIOLOGY TABLE	1/2"	1/2"	1/2"	1/2"	1/2"	1/2"	DISMOUNTED EXTRA TABLE, BY D.S. STEWART HALL - MOVE - RECONNECT
B-31	120	BIOLOGY TABLE	1/2"	1/2"	1/2"	1/2"	1/2"	1/2"	DISMOUNTED EXTRA TABLE, BY D.S. STEWART HALL - MOVE - RECONNECT
B-32	120	BIOLOGY TABLE	1/2"	1/2"	1/2"	1/2"	1/2"	1/2"	DISMOUNTED EXTRA TABLE, BY D.S. STEWART HALL - MOVE - RECONNECT
B-33	120	BIOLOGY TABLE	1/2"	1/2"	1/2"	1/2"	1/2"	1/2"	DISMOUNTED EXTRA TABLE, BY D.S. STEWART HALL - MOVE - RECONNECT
B-34	120	BIOLOGY TABLE	1/2"	1/2"	1/2"	1/2"	1/2"	1/2"	DISMOUNTED EXTRA TABLE, BY D.S. STEWART HALL - MOVE - RECONNECT
B-35	120	BIOLOGY TABLE	1/2"	1/2"	1/2"	1/2"	1/2"	1/2"	DISMOUNTED EXTRA TABLE, BY D.S. STEWART HALL - MOVE - RECONNECT
B-36	120	BIOLOGY TABLE	1/2"	1/2"	1/2"	1/2"	1/2"	1/2"	DISMOUNTED EXTRA TABLE, BY D.S. STEWART HALL - MOVE - RECONNECT
B-37	120	BIOLOGY TABLE	1/2"	1/2"	1/2"	1/2"	1/2"	1/2"	DISMOUNTED EXTRA TABLE, BY D.S. STEWART HALL - MOVE - RECONNECT
B-38	120	BIOLOGY TABLE	1/2"	1/2"	1/2"	1/2"	1/2"	1/2"	DISMOUNTED EXTRA TABLE, BY D.S. STEWART HALL - MOVE - RECONNECT
B-39	120	BIOLOGY TABLE	1/2"	1/2"	1/2"	1/2"	1/2"	1/2"	DISMOUNTED EXTRA TABLE, BY D.S. STEWART HALL - MOVE - RECONNECT
B-40	120	BIOLOGY TABLE	1/2"	1/2"	1/2"	1/2"	1/2"	1/2"	DISMOUNTED EXTRA TABLE, BY D.S. STEWART HALL - MOVE - RECONNECT
B-41	120	BIOLOGY TABLE	1/2"	1/2"	1/2"	1/2"	1/2"	1/2"	DISMOUNTED EXTRA TABLE, BY D.S. STEWART HALL - MOVE - RECONNECT
B-42	120	BIOLOGY TABLE	1/2"	1/2"	1/2"	1/2"	1/2"	1/2"	DISMOUNTED EXTRA TABLE, BY D.S. STEWART HALL - MOVE - RECONNECT
B-43	120	BIOLOGY TABLE	1/2"	1/2"	1/2"	1/2"	1/2"	1/2"	DISMOUNTED EXTRA TABLE, BY D.S. STEWART HALL - MOVE - RECONNECT
B-44	120	BIOLOGY TABLE	1/2"	1/2"	1/2"	1/2"	1/2"	1/2"	DISMOUNTED EXTRA TABLE, BY D.S. STEWART HALL - MOVE - RECONNECT
B-45	120	BIOLOGY TABLE	1/2"	1/2"	1/2"	1/2"	1/2"	1/2"	DISMOUNTED EXTRA TABLE, BY D.S. STEWART HALL - MOVE - RECONNECT
B-46	120	BIOLOGY TABLE	1/2"	1/2"	1/2"	1/2"	1/2"	1/2"	DISMOUNTED EXTRA TABLE, BY D.S. STEWART HALL - MOVE - RECONNECT
B-47	120	BIOLOGY TABLE	1/2"	1/2"	1/2"	1/2"	1/2"	1/2"	DISMOUNTED EXTRA TABLE, BY D.S. STEWART HALL - MOVE - RECONNECT
B-48	120	BIOLOGY TABLE	1/2"	1/2"	1/2"	1/2"	1/2"	1/2"	DISMOUNTED EXTRA TABLE, BY D.S. STEWART HALL - MOVE - RECONNECT
B-49	120	BIOLOGY TABLE	1/2"	1/2"	1/2"	1/2"	1/2"	1/2"	DISMOUNTED EXTRA TABLE, BY D.S. STEWART HALL - MOVE - RECONNECT
B-50	120	BIOLOGY TABLE	1/2"	1/2"	1/2"	1/2"	1/2"	1/2"	DISMOUNTED EXTRA TABLE, BY D.S. STEWART HALL - MOVE - RECONNECT

BUILDING CROSS-SECTION

SECTION THRU CORRIDOR, SUSPENDED CEILING

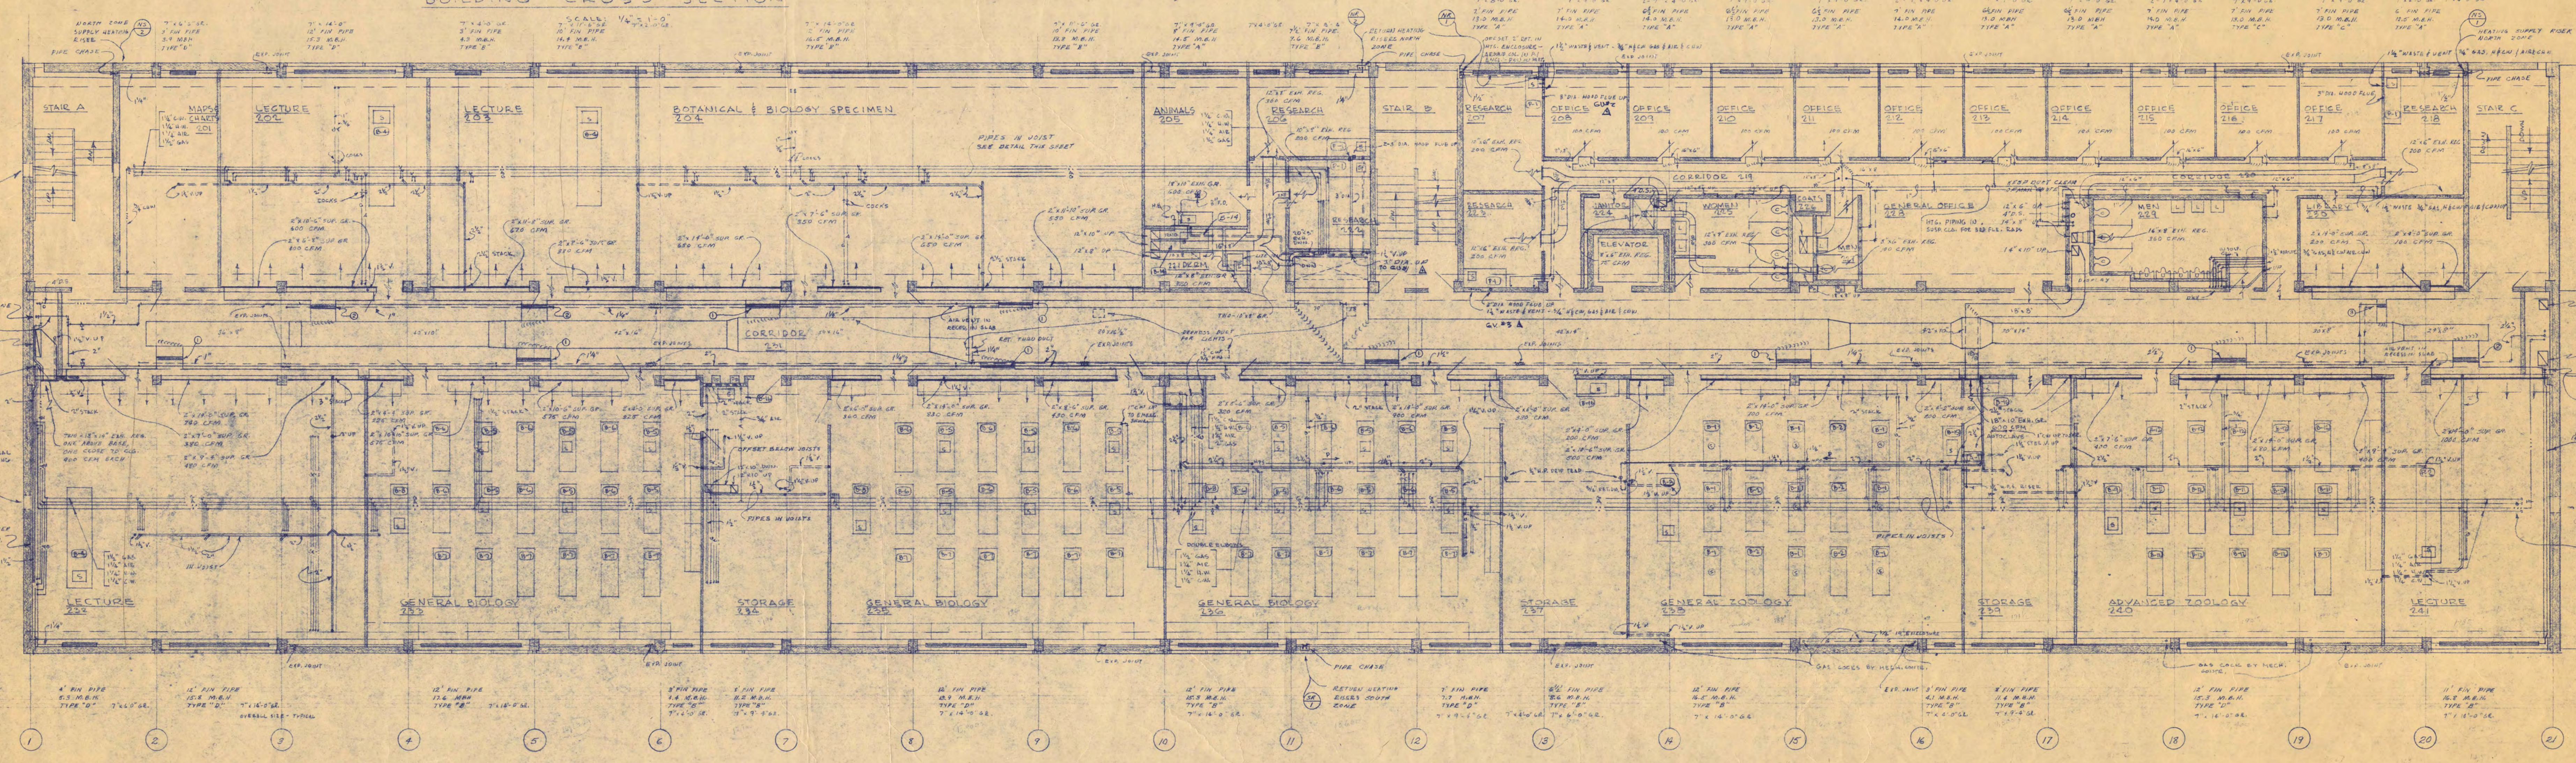

SECOND FLOOR MECHANICAL PLAN

SCIENCE AND MATHEMATICS BUILDING
ST. CLOUD STATE COLLEGE
ST. CLOUD, MINNESOTA

DEPARTMENT OF ADMINISTRATION STATE OF MINNESOTA
ROOM 120 STATE CAPITOL BUILDING ST. PAUL, MINNESOTA
ARCHITECTURAL AND ENGINEERING DIVISION



AJ. NELSON, STATE ARCHITECT

TRAYNOR AND HERMANSON, ARCHITECTS ST. CLOUD, MINN.
BAUMANN AND MOORE, INC. CONSULTING ENGINEERS ST. PAUL, MINN.
JOHNSTON, BAUMANN CO. STRUCTURAL ENGINEERS MINNEAPOLIS, MINN.

DATE: 1/15/37
APPROVED BY: PRESIDENT OF ST. CLOUD STATE COLLEGE
DRAWN BY: [Signature]
CHECKED BY: [Signature]


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APPROVED BY: COMMISSIONERS OF ADMINISTRATION
AN AUTHORIZED SIGNATURE

M-4
OF 5
STATE PROJECT NUMBER
2400

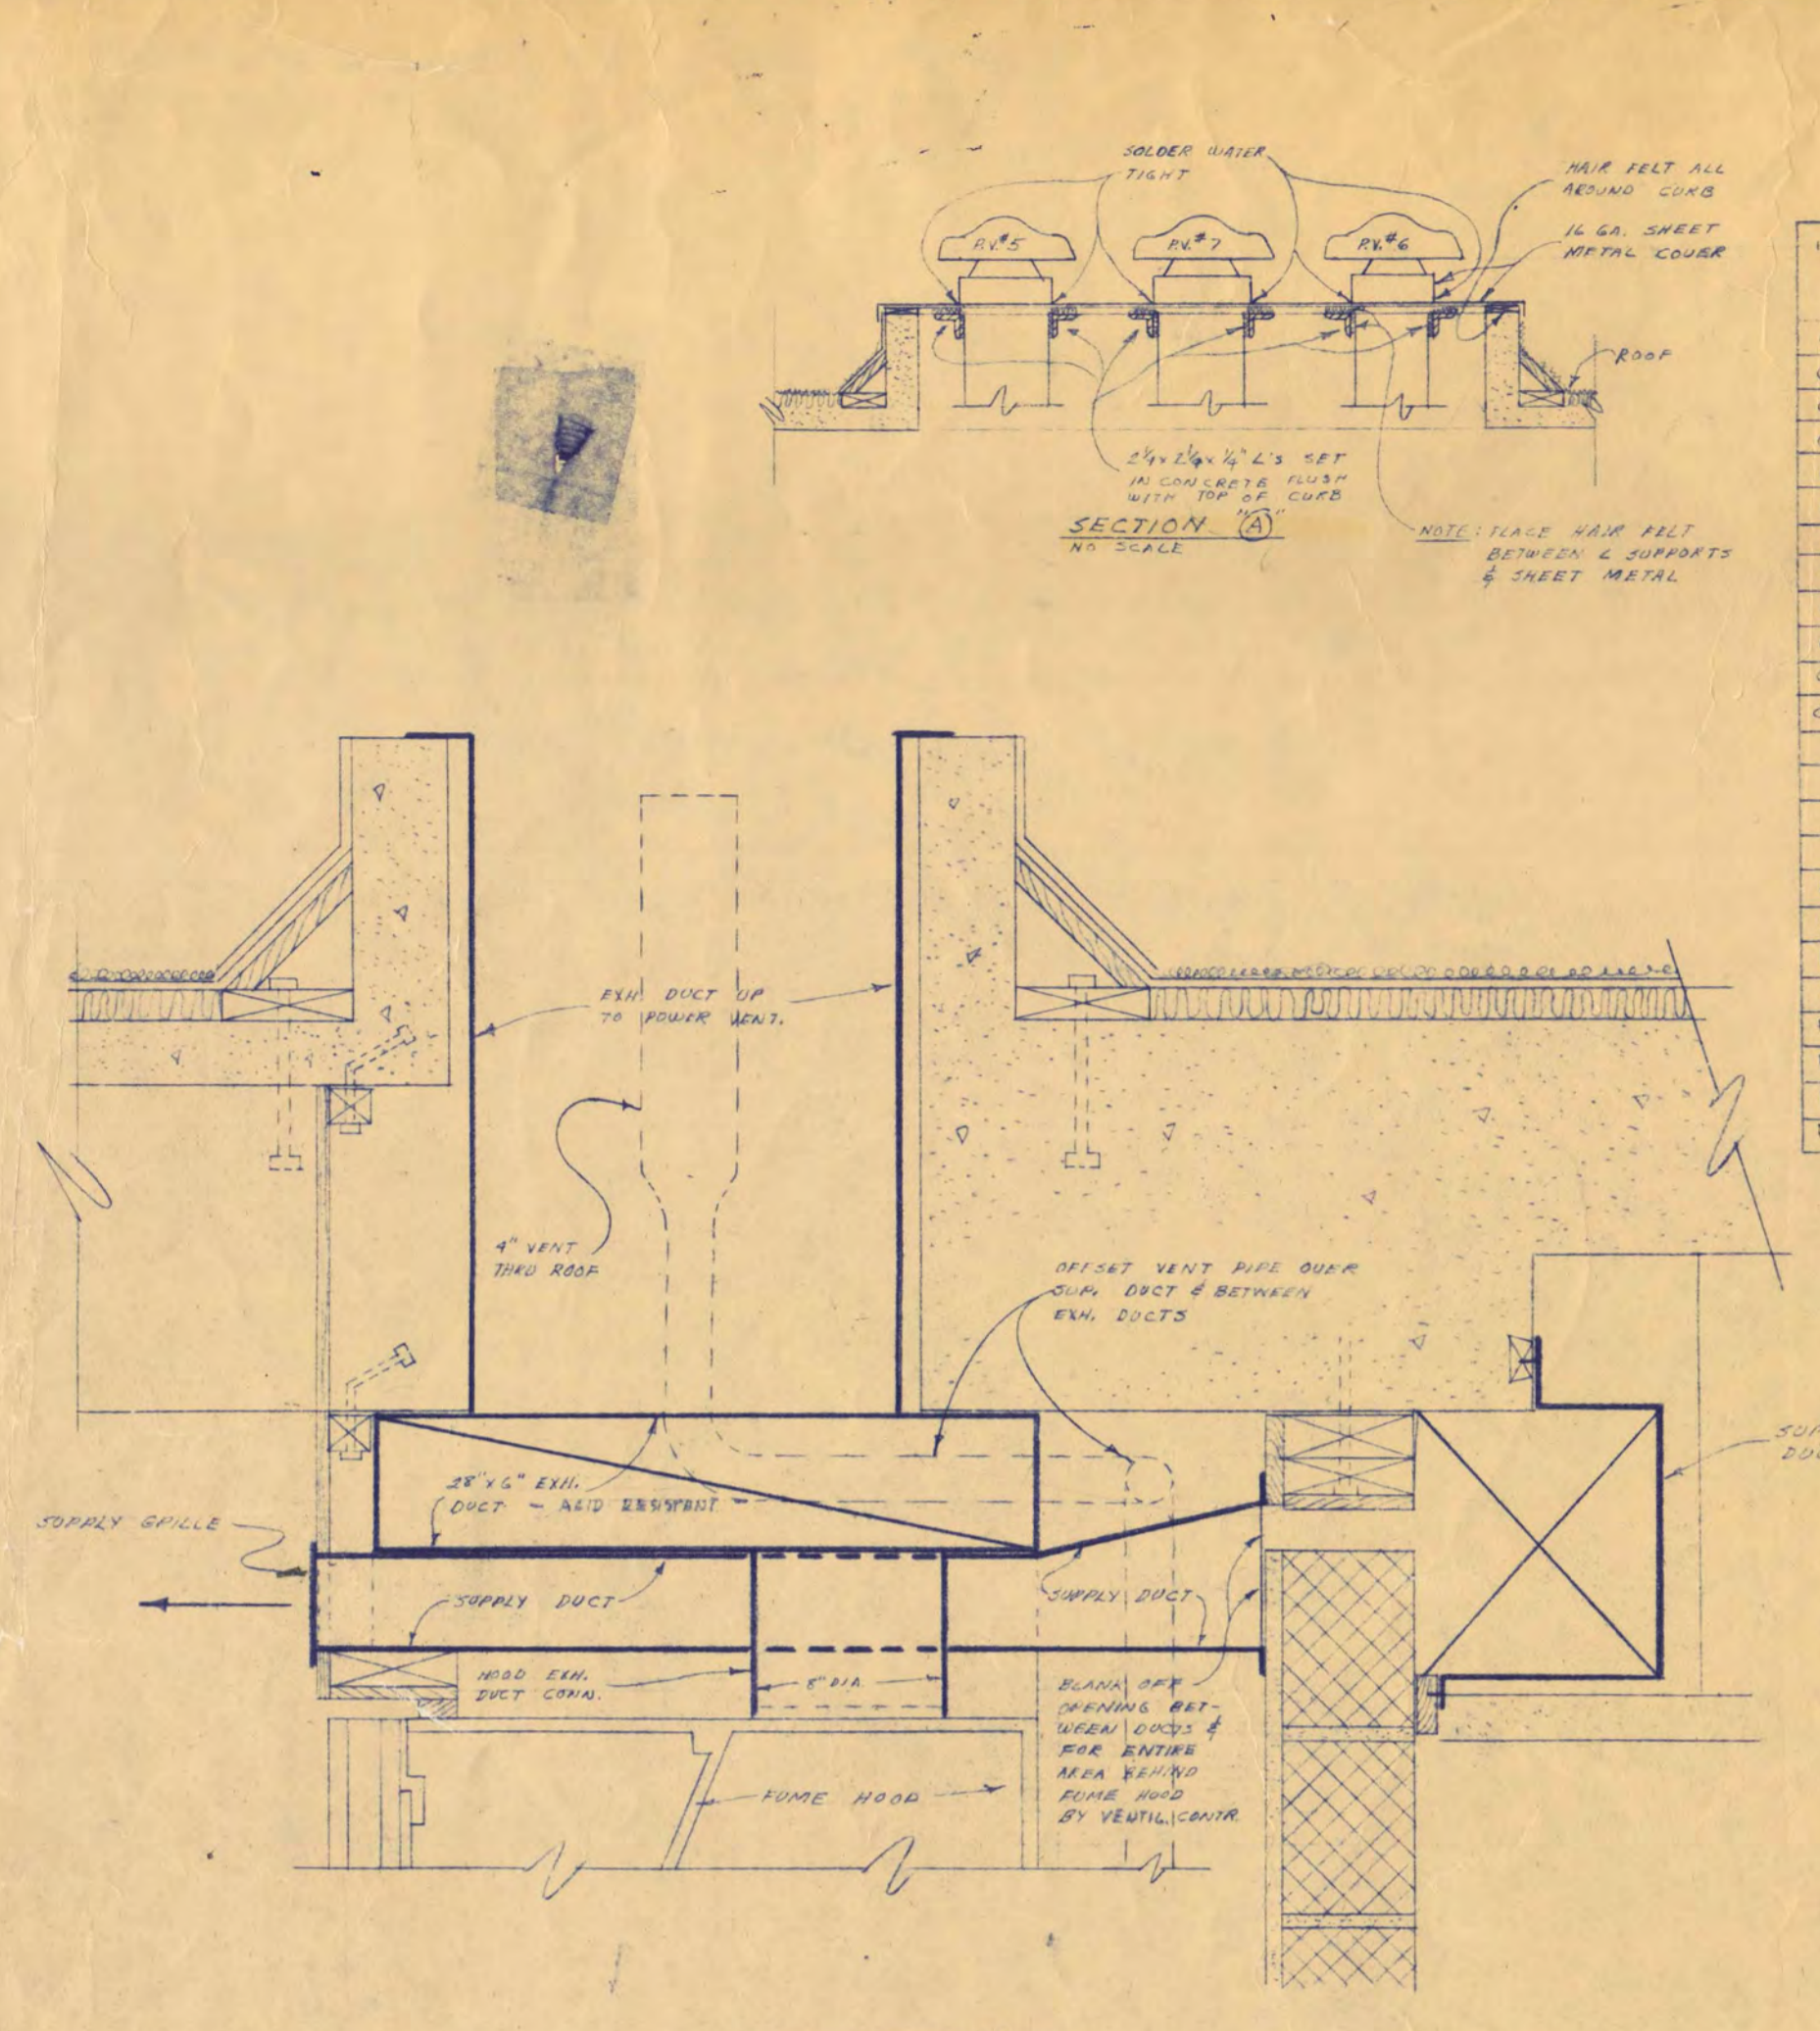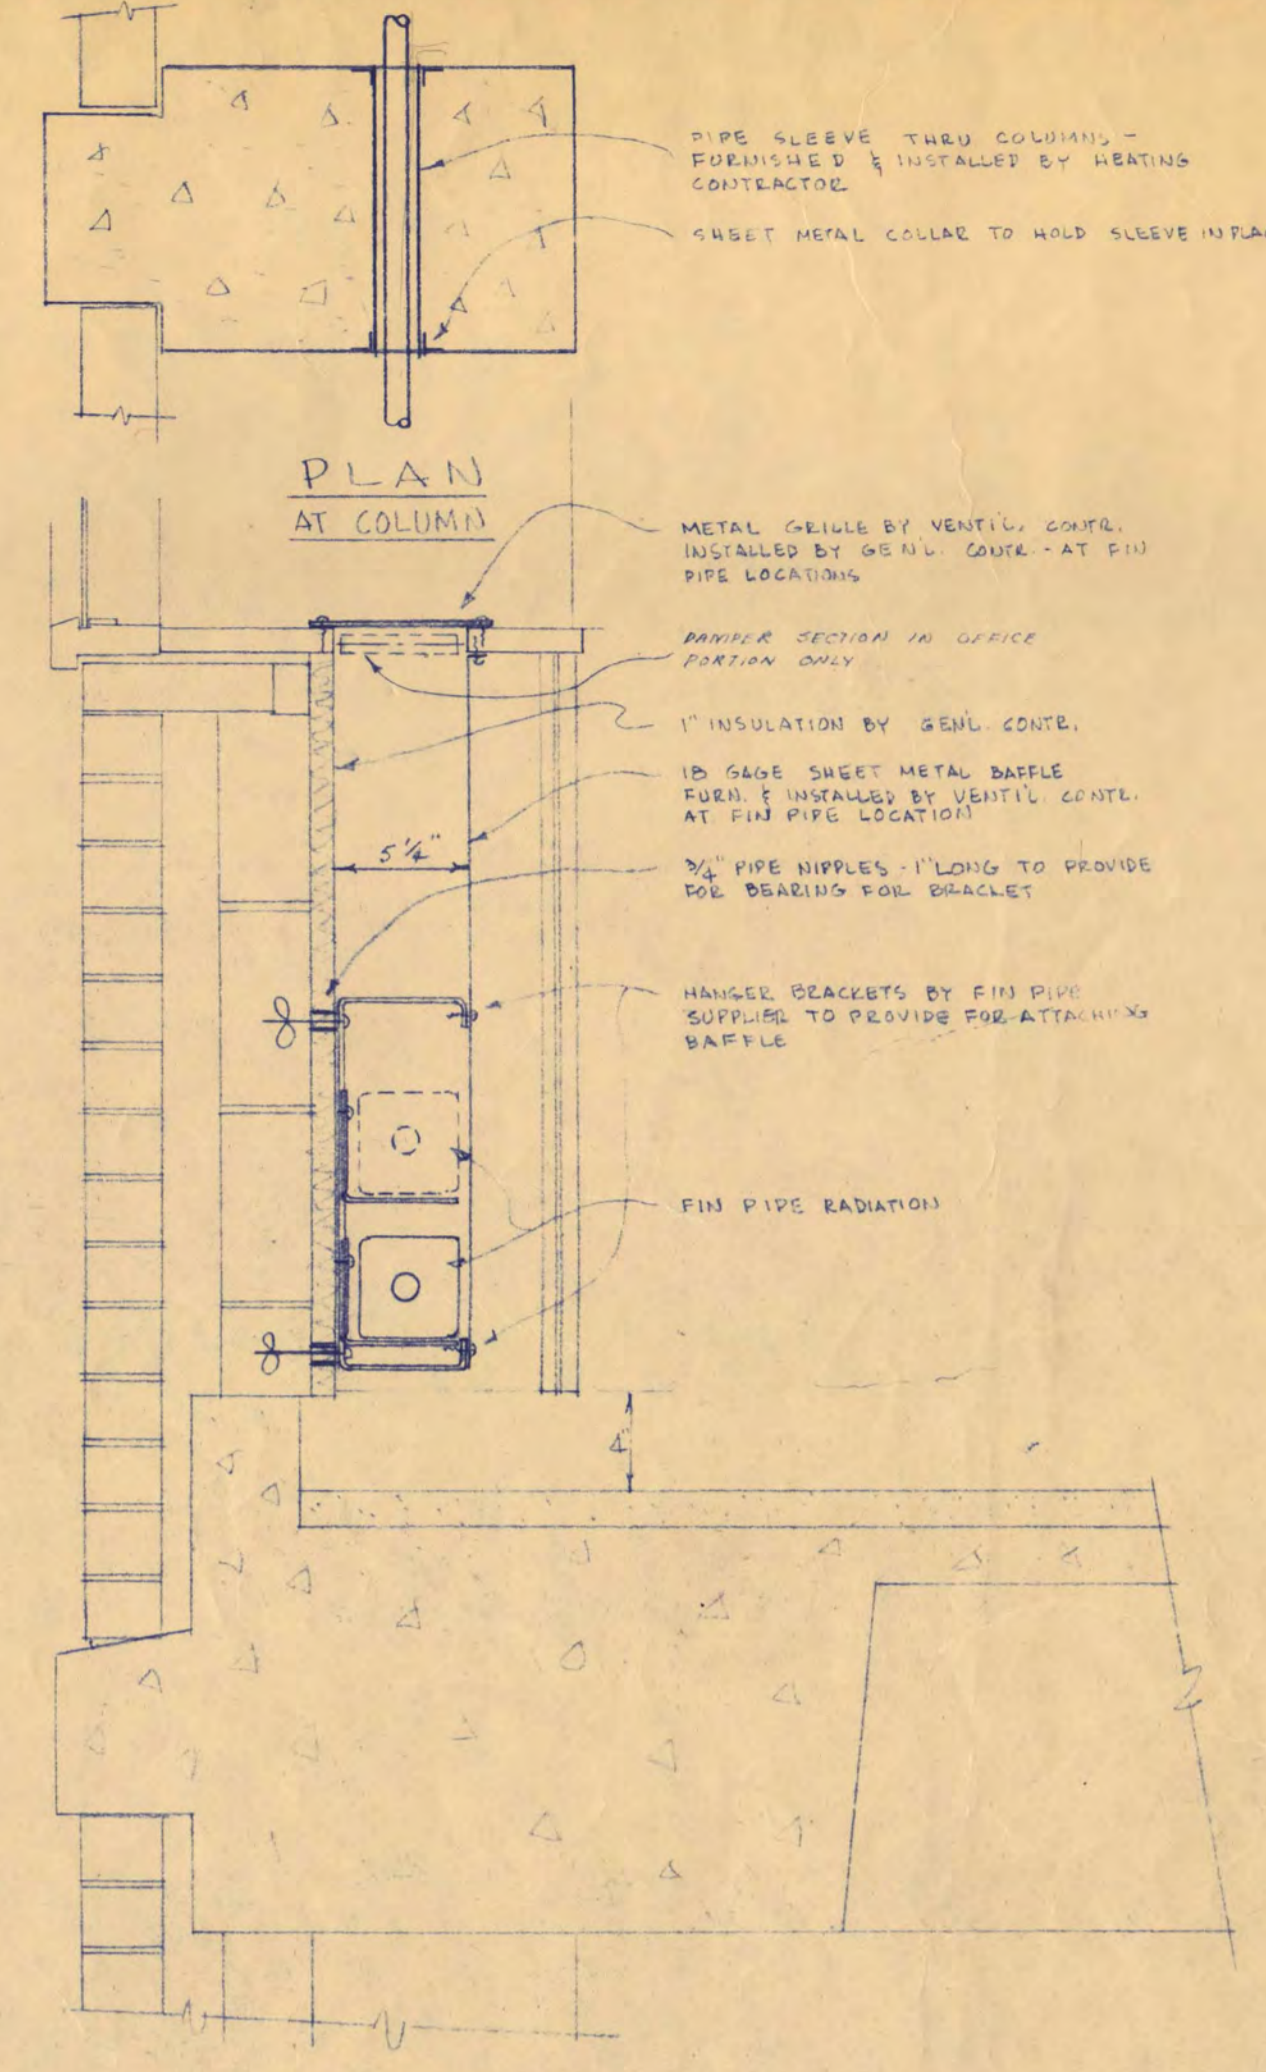


LABORATORY EQUIPMENT SCHEDULE

ITEM NO.	EQUIPMENT DESCRIPTION	ROOM NO.	GAS	H.W.	C.W.	COFFER	STEAM	WASTE	REMARKS
C-1	LAD. TABLE - EXIST.	347	1"	1/2"	1/2"	1"	1/2"	1/2"	CONNECT TABLE TO S.S. WASTEWATER HALL - MORE RECONNECT
C-2	FUME HOOD - EXIST.	347	1/2"	1/2"	1/2"	1"	1/2"	1/2"	DISCONNECT HOOD FROM S.S. WASTEWATER HALL - MORE RECONNECT
C-3	LAD. TABLE - NEW	348	1"	1/2"	1/2"	1"	1/2"	1/2"	CONNECT TO S.S. WASTEWATER HALL - MORE RECONNECT
C-4	FUME HOOD - NEW	348	1/2"	1/2"	1/2"	1"	1/2"	1/2"	CONNECT TO S.S. WASTEWATER HALL - MORE RECONNECT
C-5	FUME HOOD - NEW	348	1/2"	1/2"	1/2"	1"	1/2"	1/2"	CONNECT TO S.S. WASTEWATER HALL - MORE RECONNECT
C-6	LAD. TABLE - NEW	348	1"	1/2"	1/2"	1"	1/2"	1/2"	CONNECT TO S.S. WASTEWATER HALL - MORE RECONNECT
C-7	PREPARATION TABLE	347	1/2"	1/2"	1/2"	1"	1/2"	1/2"	CONNECT TO S.S. WASTEWATER HALL - MORE RECONNECT
C-8	SHRELVING	347	1/2"	1/2"	1/2"	1"	1/2"	1/2"	CONNECT TO S.S. WASTEWATER HALL - MORE RECONNECT
C-9	FUME HOOD - NEW	347	1/2"	1/2"	1/2"	1"	1/2"	1/2"	CONNECT TO S.S. WASTEWATER HALL - MORE RECONNECT
C-10	PREPARATION TABLE	347	1/2"	1/2"	1/2"	1"	1/2"	1/2"	CONNECT TO S.S. WASTEWATER HALL - MORE RECONNECT
C-11	INSPECTOR TABLE	347	1/2"	1/2"	1/2"	1"	1/2"	1/2"	CONNECT TO S.S. WASTEWATER HALL - MORE RECONNECT
C-12	COUNTER	347	1/2"	1/2"	1/2"	1"	1/2"	1/2"	CONNECT TO S.S. WASTEWATER HALL - MORE RECONNECT
P-1	INTERCOM. TABLE NEW	347	1/2"	1/2"	1/2"	1"	1/2"	1/2"	CONNECT TO S.S. WASTEWATER HALL - MORE RECONNECT
P-2	INTERCOM. TABLE NEW	347	1/2"	1/2"	1/2"	1"	1/2"	1/2"	CONNECT TO S.S. WASTEWATER HALL - MORE RECONNECT
P-3	SERVICE ISLAND	347	1/2"	1/2"	1/2"	1"	1/2"	1/2"	CONNECT TO S.S. WASTEWATER HALL - MORE RECONNECT
P-4	SERVICE ISLAND	347	1/2"	1/2"	1/2"	1"	1/2"	1/2"	CONNECT TO S.S. WASTEWATER HALL - MORE RECONNECT
P-5	SINK TOP	347	1/2"	1/2"	1/2"	1"	1/2"	1/2"	CONNECT TO S.S. WASTEWATER HALL - MORE RECONNECT
P-6	SINK TOP	347	1/2"	1/2"	1/2"	1"	1/2"	1/2"	CONNECT TO S.S. WASTEWATER HALL - MORE RECONNECT
P-7	SINK TOP	347	1/2"	1/2"	1/2"	1"	1/2"	1/2"	CONNECT TO S.S. WASTEWATER HALL - MORE RECONNECT
P-8	SINK TOP	347	1/2"	1/2"	1/2"	1"	1/2"	1/2"	CONNECT TO S.S. WASTEWATER HALL - MORE RECONNECT

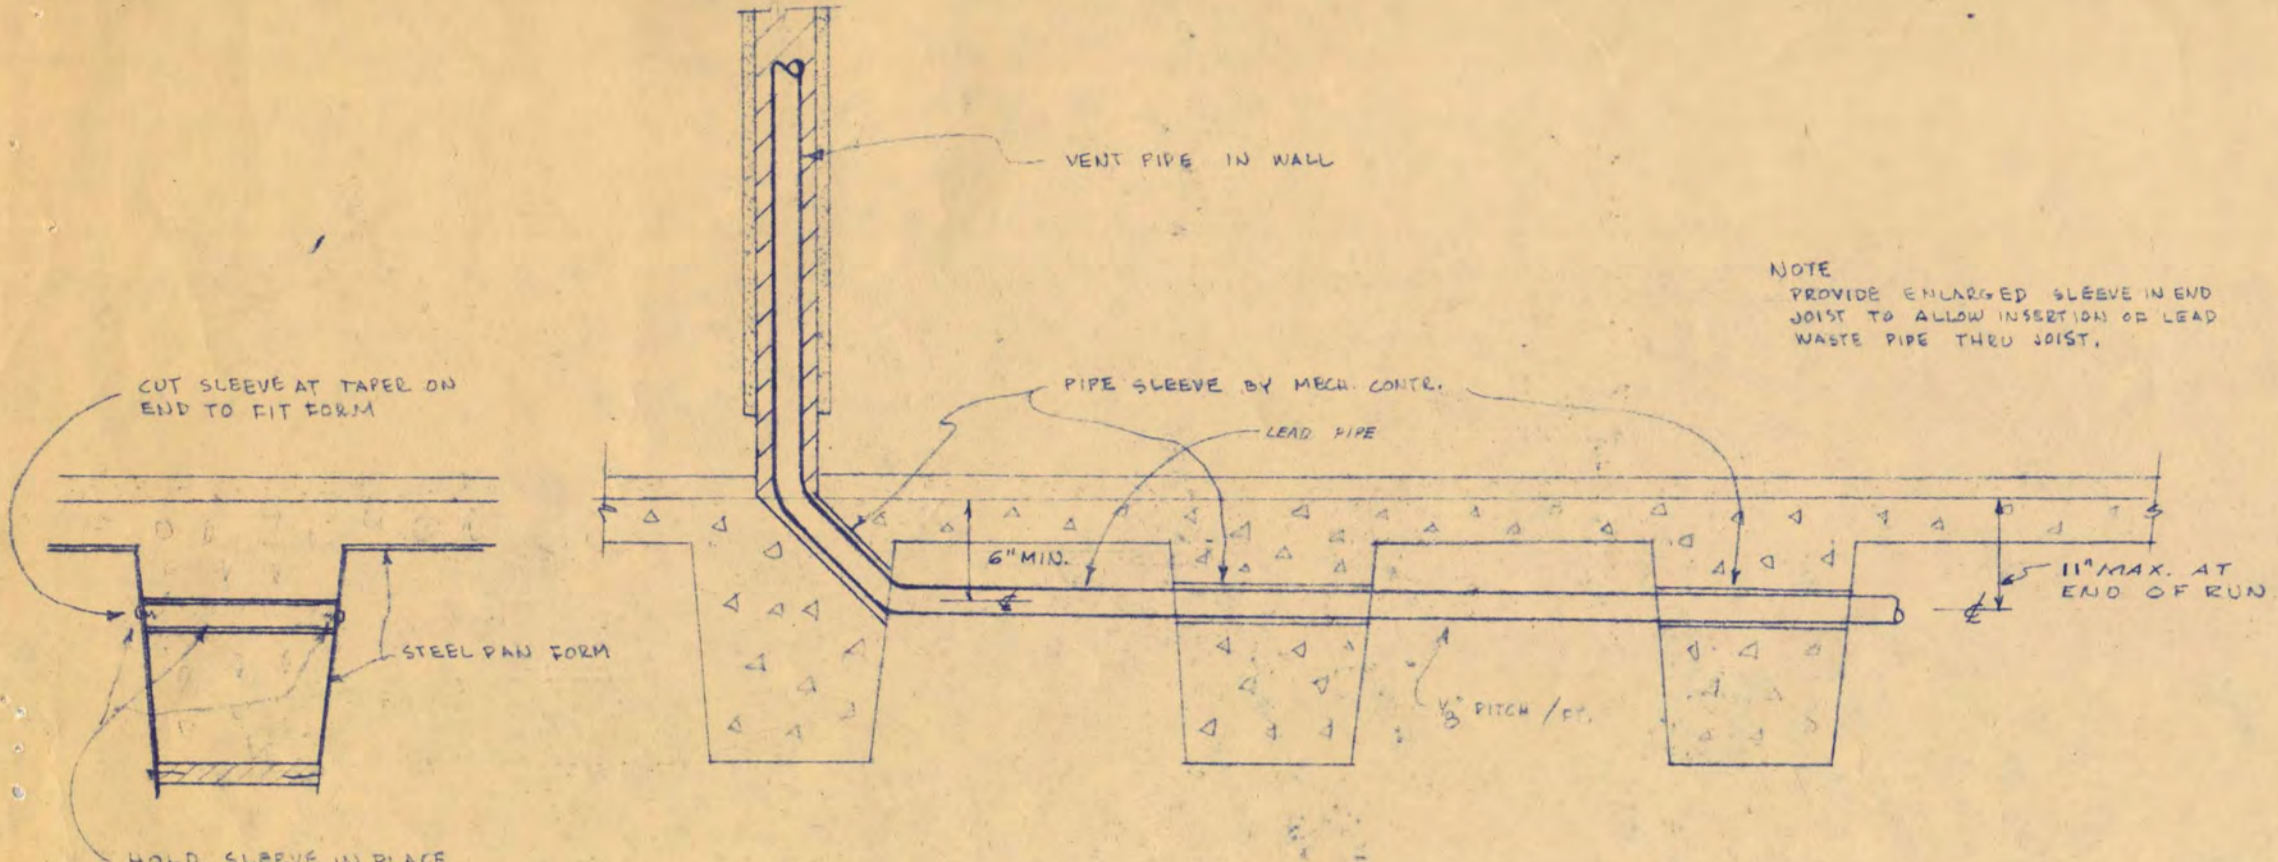

DETAIL OF WASTE & VENT PIPING THRU JOISTS
SCALE 1" = 1'-0"

FIN PIPE DETAIL AT OUTSIDE WALL
SCALE 1/2" = 1'-0"

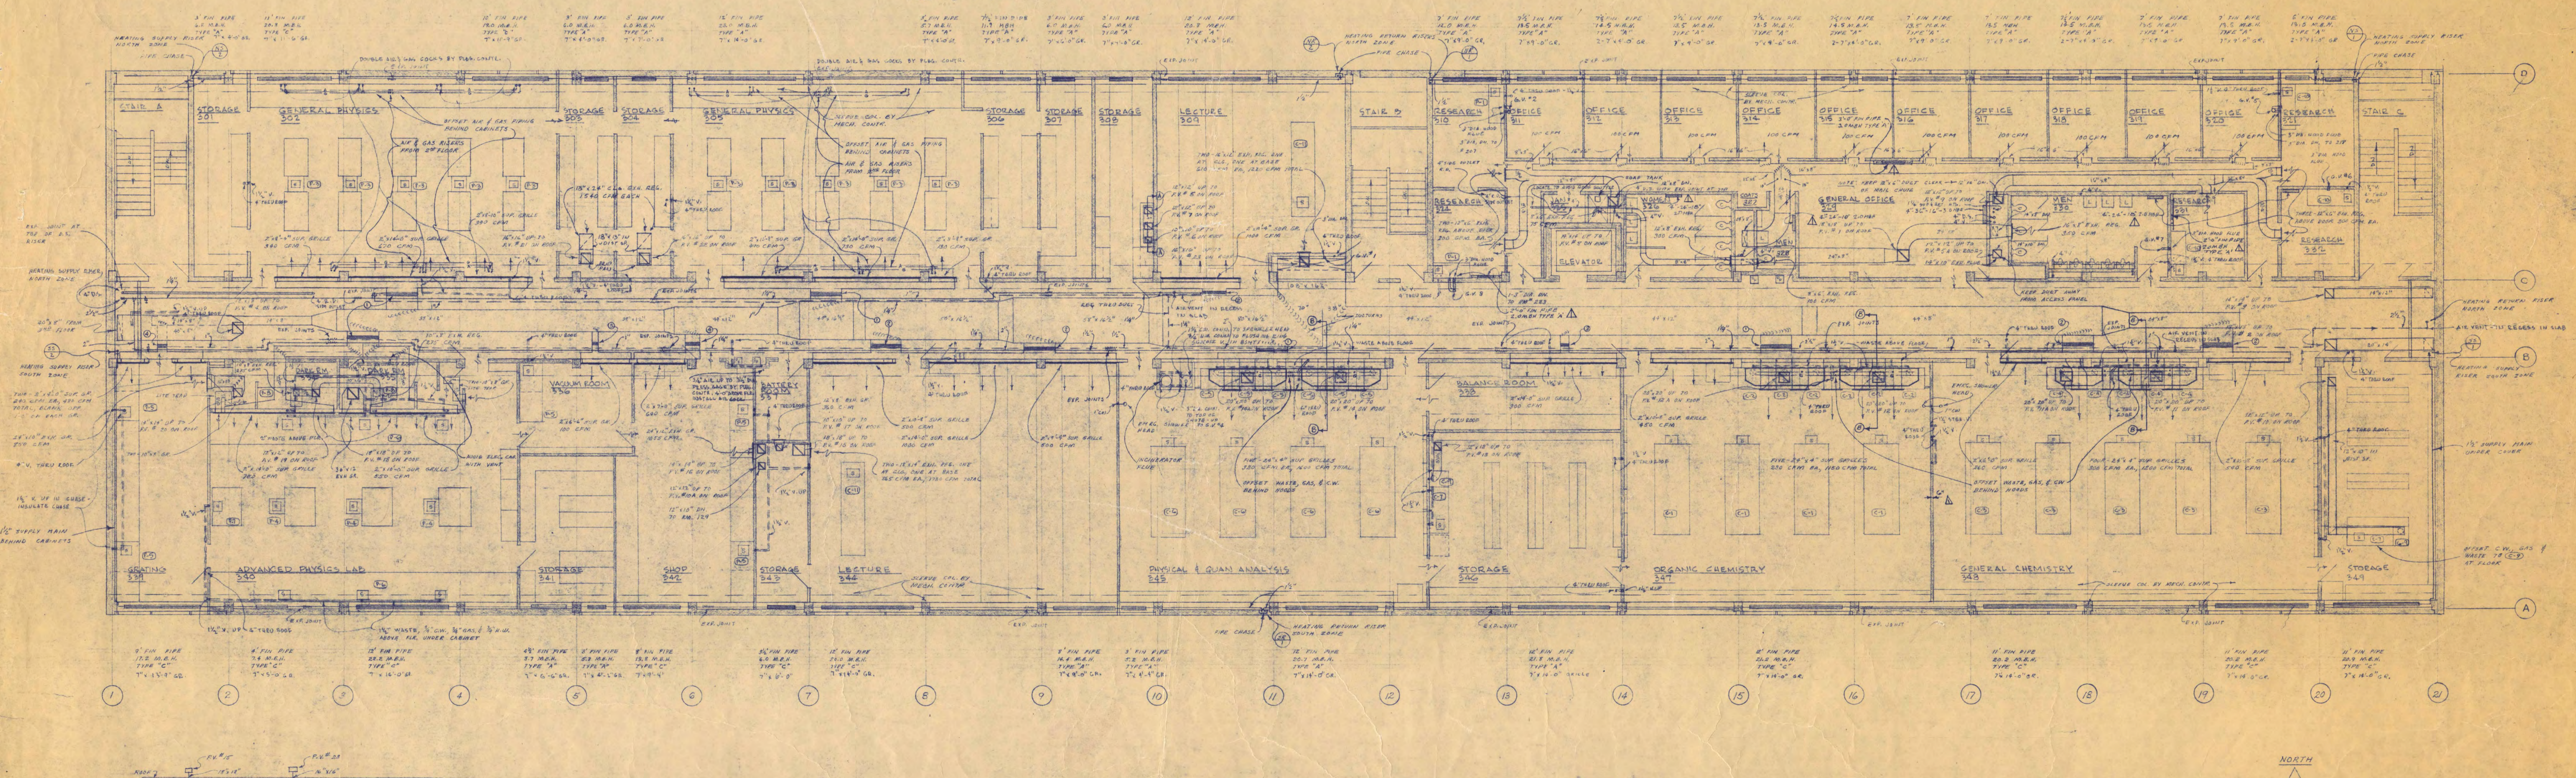

THIRD FLOOR MECHANICAL PLAN
SCALE 3/8" = 1'-0"

EXH. RISER DIAGRAM
AS SCALE



SCIENCE AND MATHEMATICS BUILDING
ST. CLOUD STATE COLLEGE
ST. CLOUD, MINNESOTA

DEPARTMENT OF ADMINISTRATION STATE OF MINNESOTA
ROOM 120 STATE CAPITOL BUILDING ST. PAUL, MINNESOTA
ARCHITECTURAL AND ENGINEERING DIVISION

A.J. NELSON, STATE ARCHITECT



TRAYNOR AND HERMANSON, ARCHITECTS
BARBARAN AND MOORE, INC. CONSULTING ENGINEERS
JOHNSTON BAHLMAN CO. STRUCTURAL ENGINEERS

ST. CLOUD, MINN.
BY PAUL W. HINN
MINNEAPOLIS, MINN.


DATE: 7-26-57
REVISED: 8-2-57
DRAWN BY: J.E.G.
CHECKED BY: J.E.G.

APPROVED BY PRESIDENT ST. CLOUD STATE COLLEGE
APPROVED BY STATE COLLEGE BOARD
APPROVED BY COMMISSIONER OF ADMINISTRATION
AN AUTHORIZED SIGNATURE


SHEET NO. M-5
OF 7
STATE PROJECT NUMBER 1600

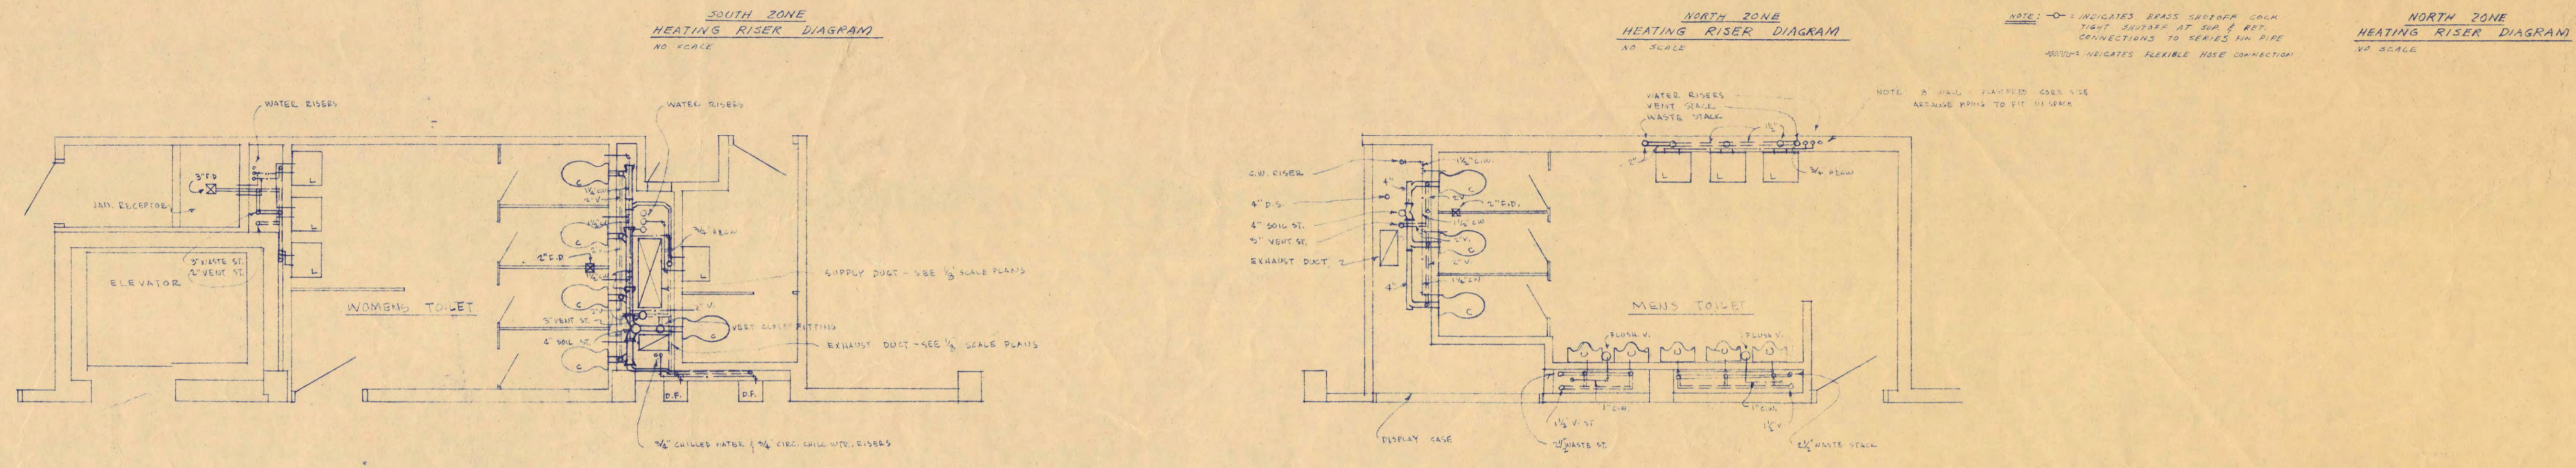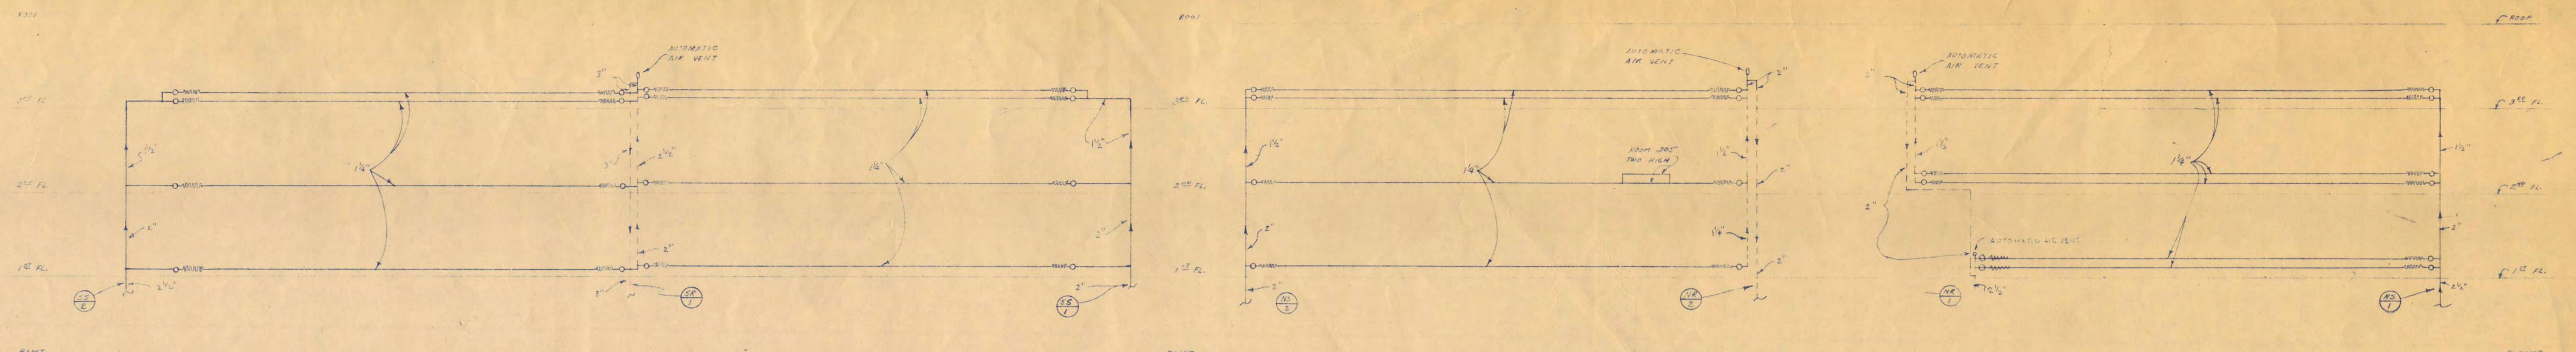

TOILET ROOM PLUMBING PLANS
SCALE: 1/4" = 1'-0"
TYPICAL FOR FIRST, SECOND, THIRD FLOOR

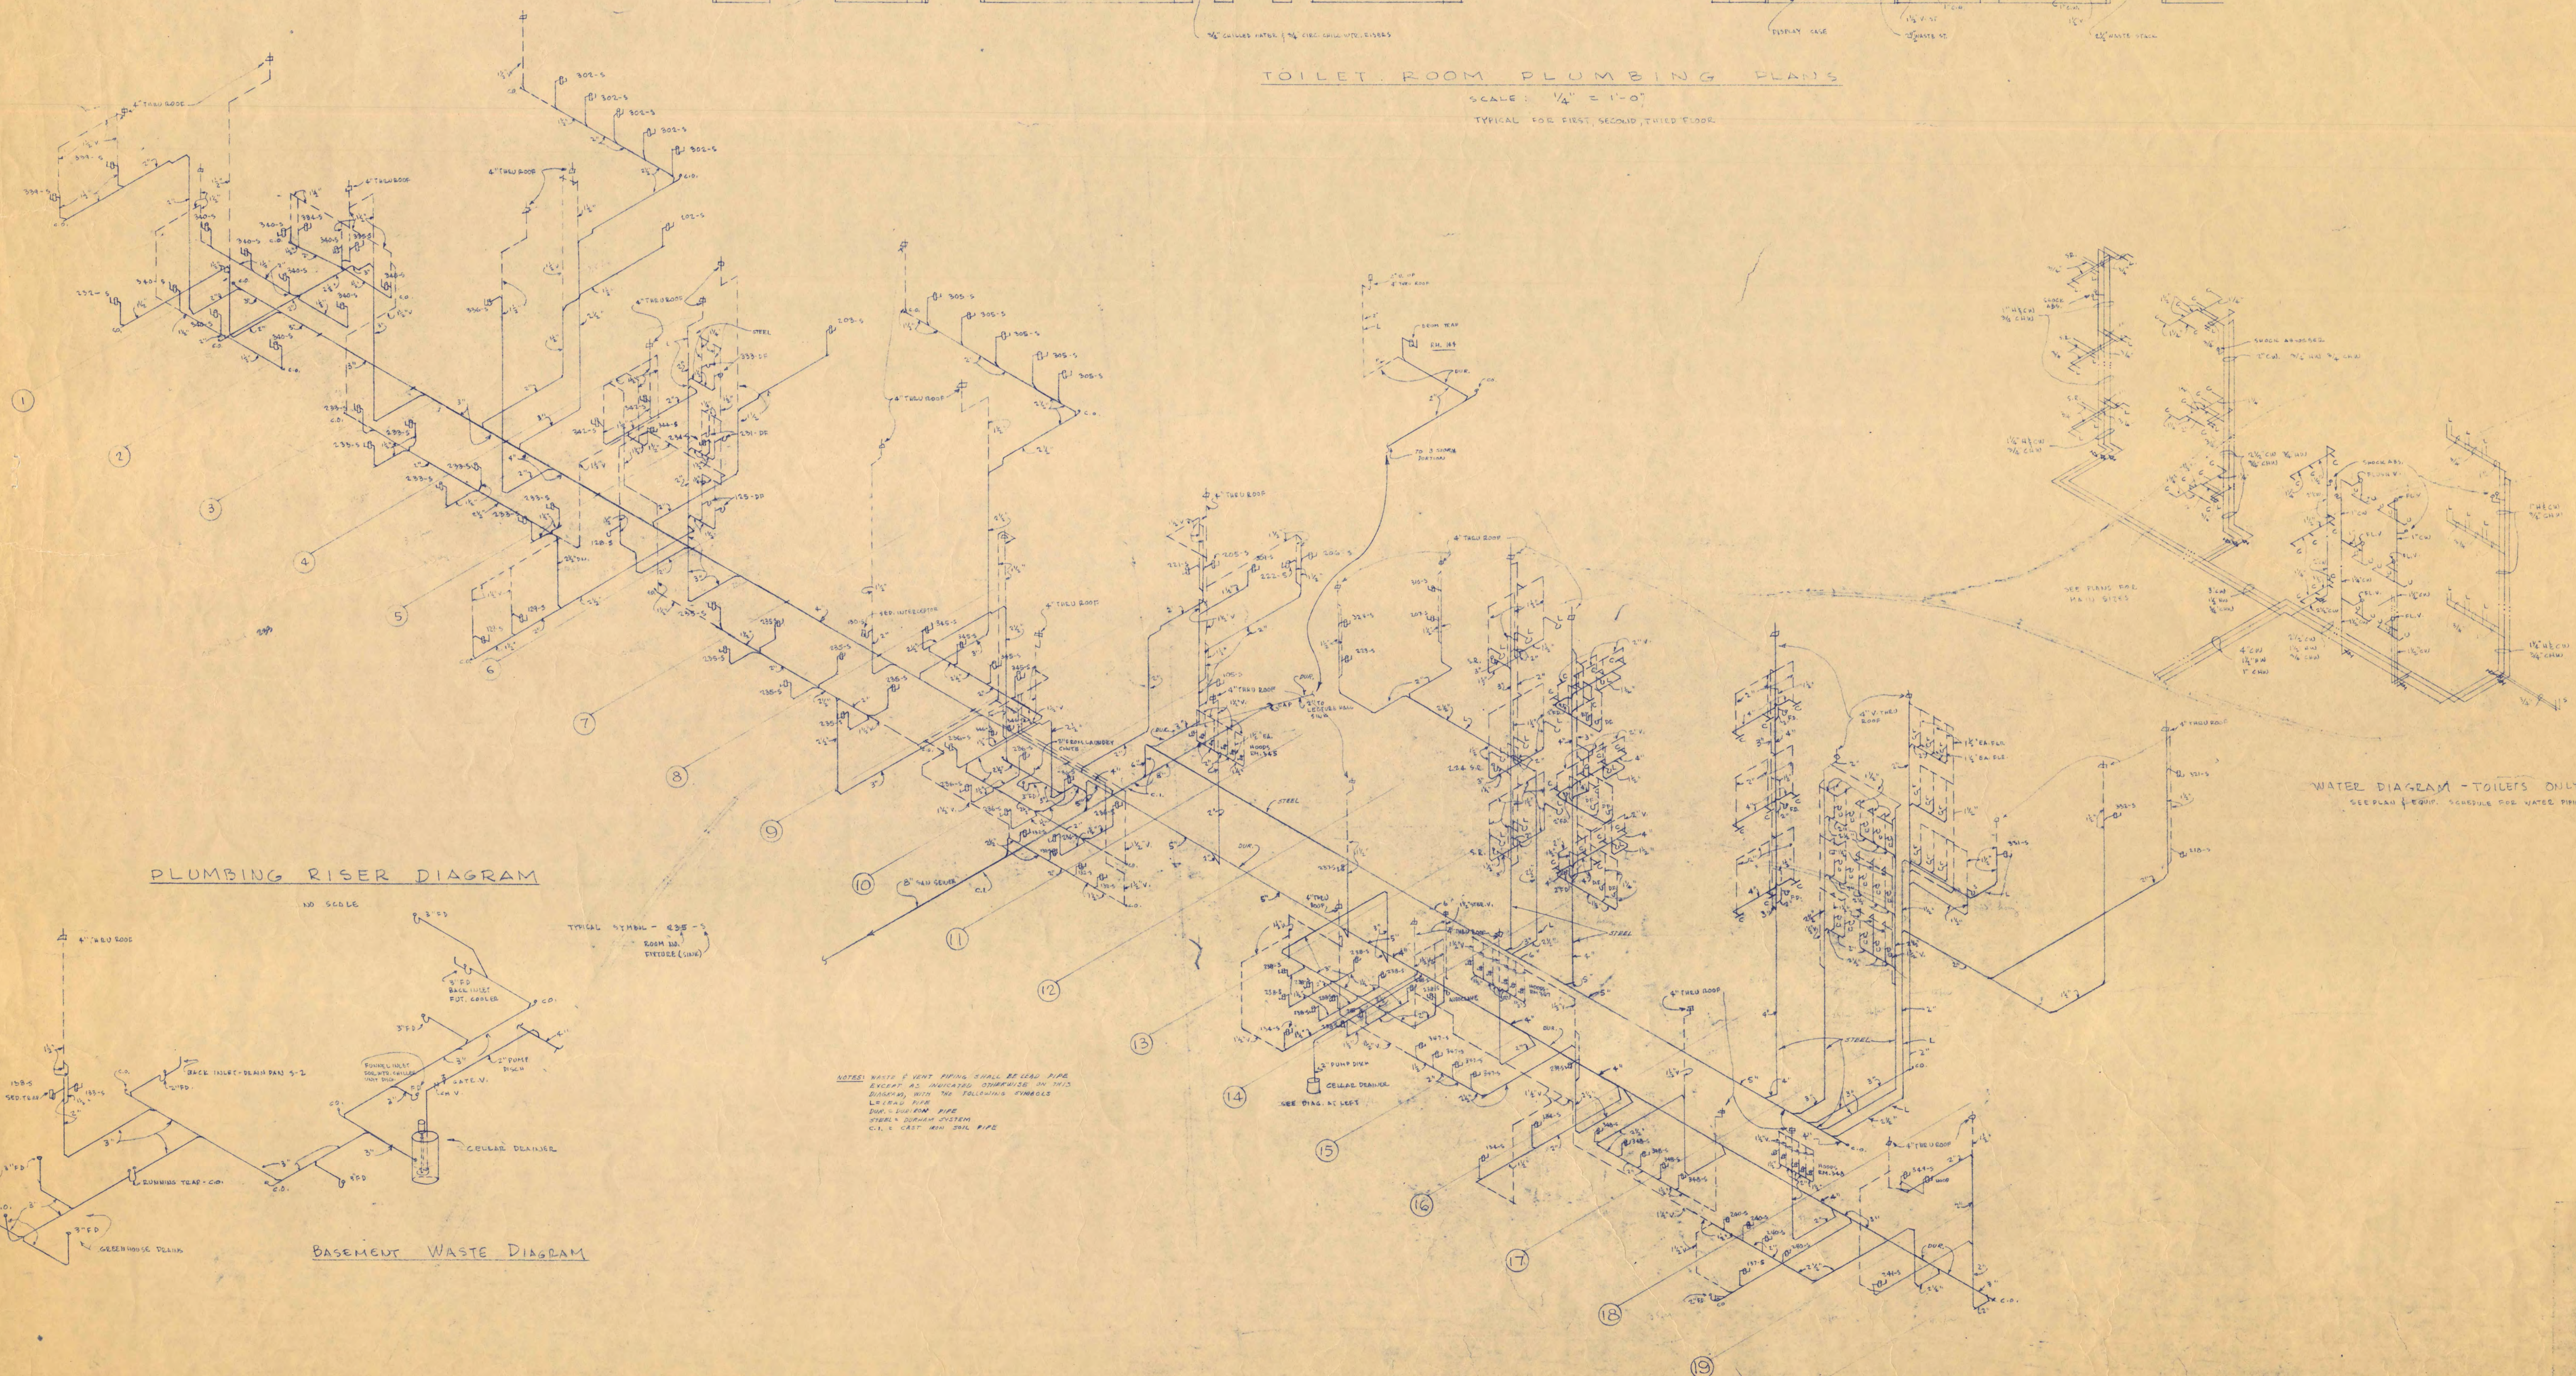


WATER DIAGRAM - TOILETS ONLY
SEE PLAN (A-10) FOR WATER PIPING









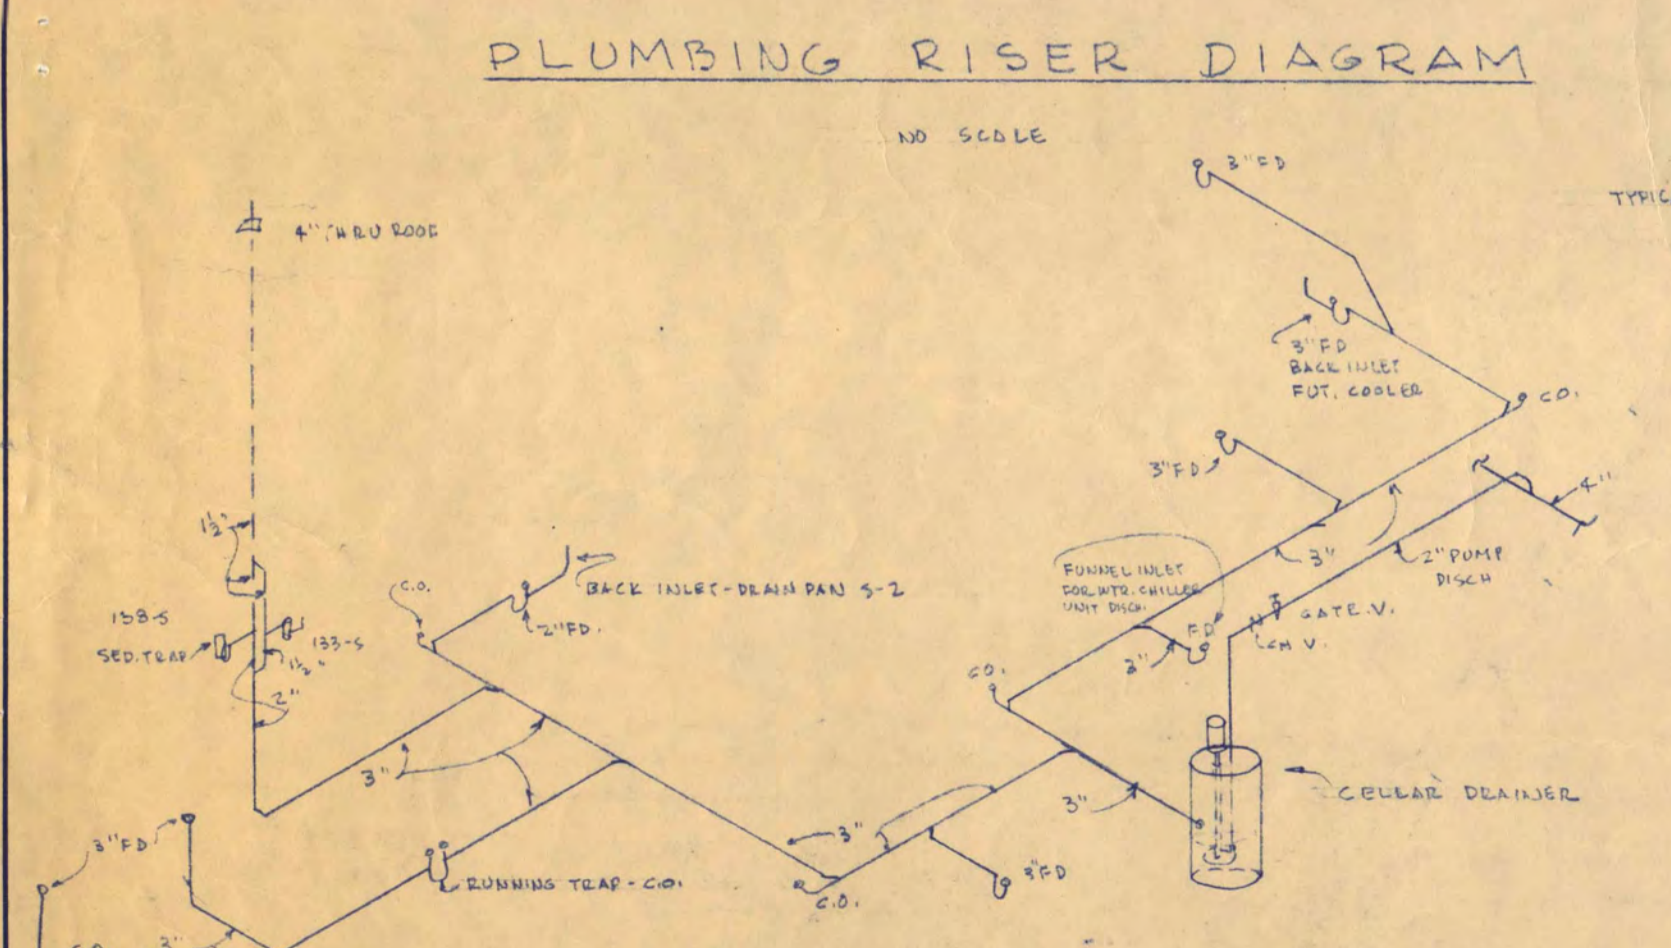


NOTE: WASTE & VENT FROM CHILL REFRIG. PIPE
EXTEND AS INDICATED THEREAFTER IN THIS
DIAGRAM WITH THE FOLLOWING DIMENSIONS
W/ TRAP AIR
DRAIN 1/2\"/>


SCIENCE AND MATHEMATICS BUILDING ST. CLOUD STATE COLLEGE ST. CLOUD, MINNESOTA		ST. CLOUD, MINN. ST. PAUL, MINN. MINNEAPOLIS, MINN.
DEPARTMENT OF ADMINISTRATION ARCHITECTURAL AND ENGINEERING DIVISION		
A.J. NELSON, STATE ARCHITECT		ST. CLOUD, MINN.
TRAYNOR AND HERMANSON, ARCHITECTS		ST. PAUL, MINN.
REVISIONS		DATE
APPROVED BY	PRESIDENT ST. CLOUD STATE COLLEGE	11/11/28
APPROVED BY	STATE COLLEGE BOARD	11/11/28
APPROVED BY	COMMISSIONER OF ADMINISTRATION AN AUTHORIZED SIGNATURE	
SHEET NO. M-6		OF 7 STATE PROJECT NUMBER 2600
DRAWN BY		

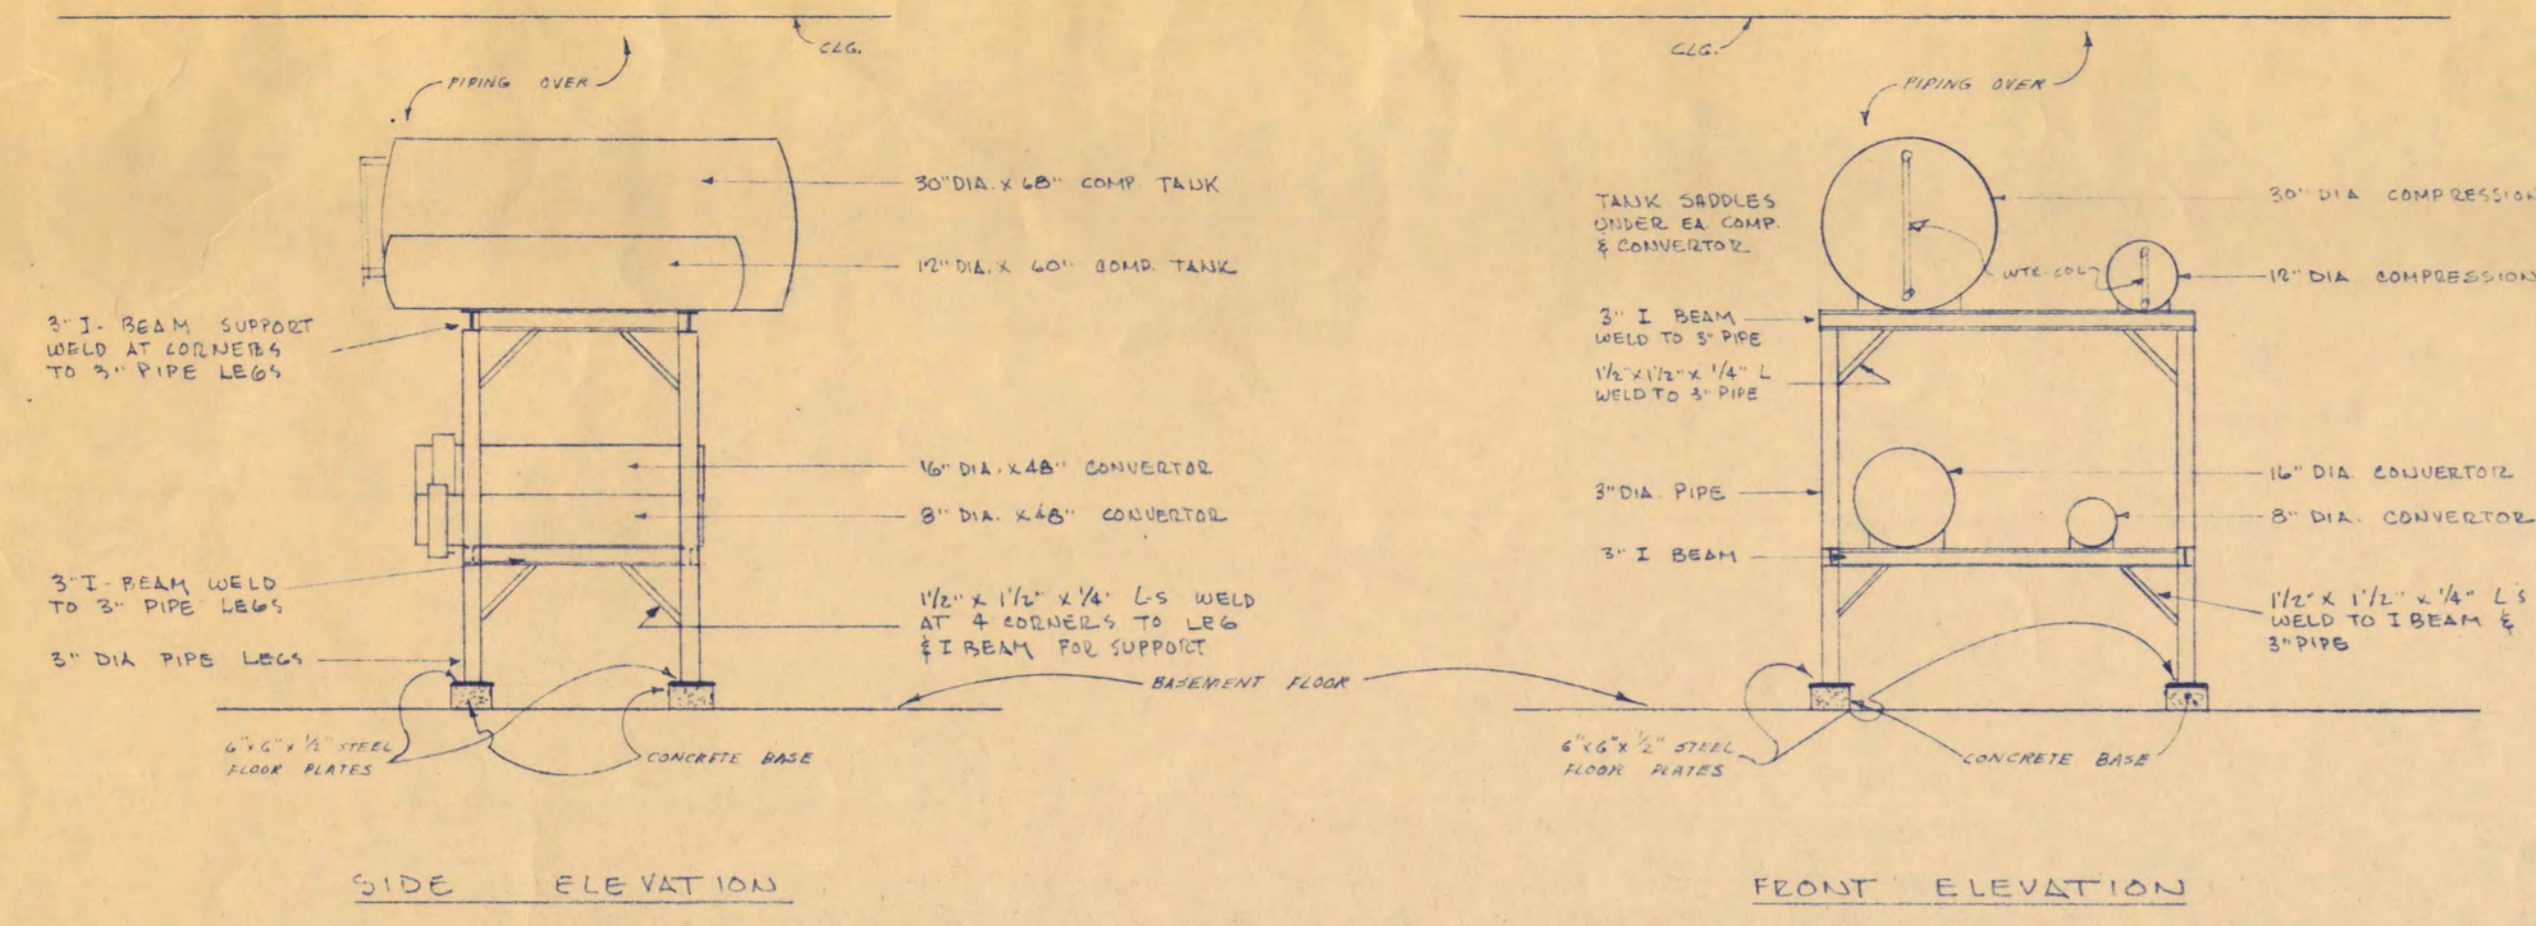






CONVERTERS & COMPRESSION TANKS STAND DETAIL
SCALE 3/8" = 1'-0"

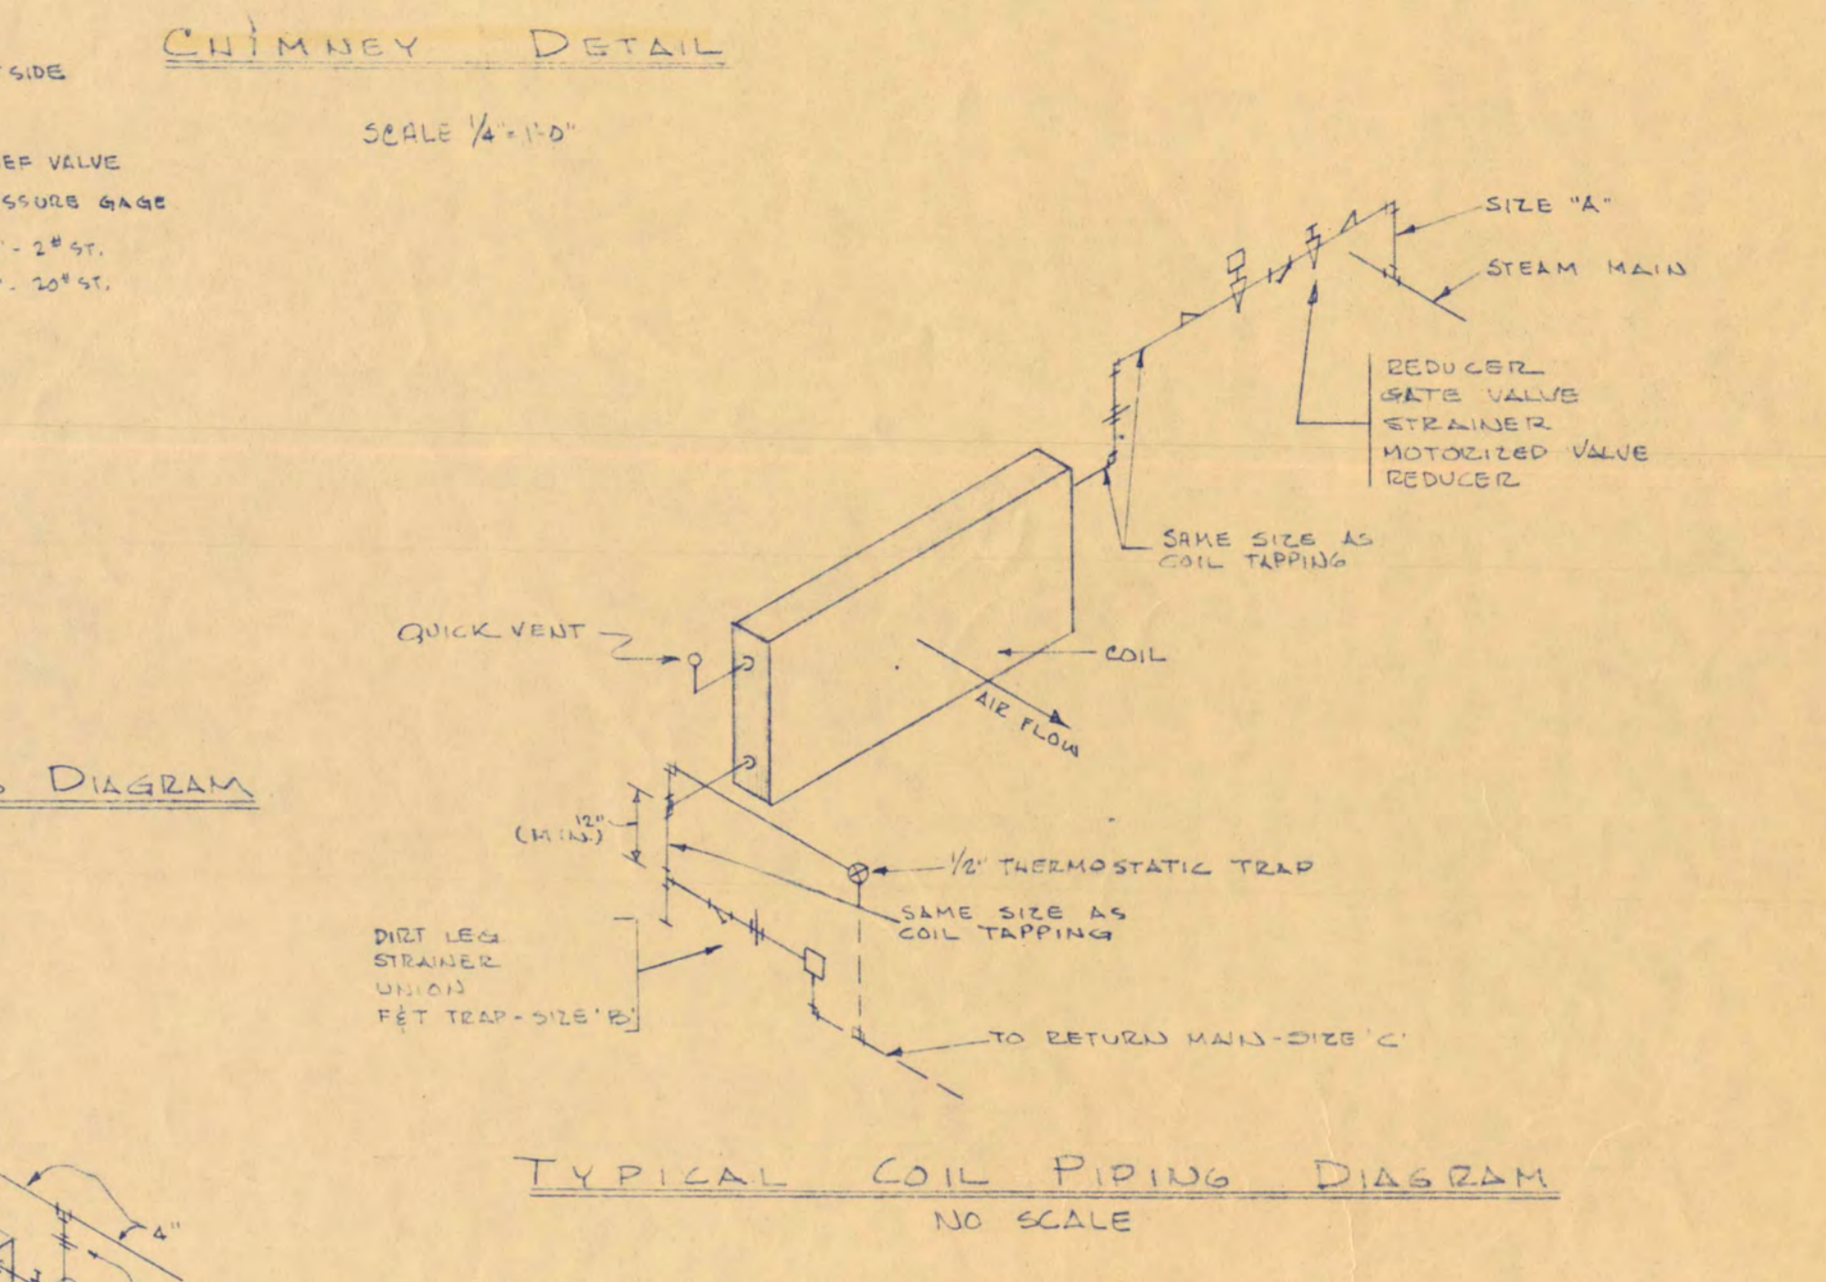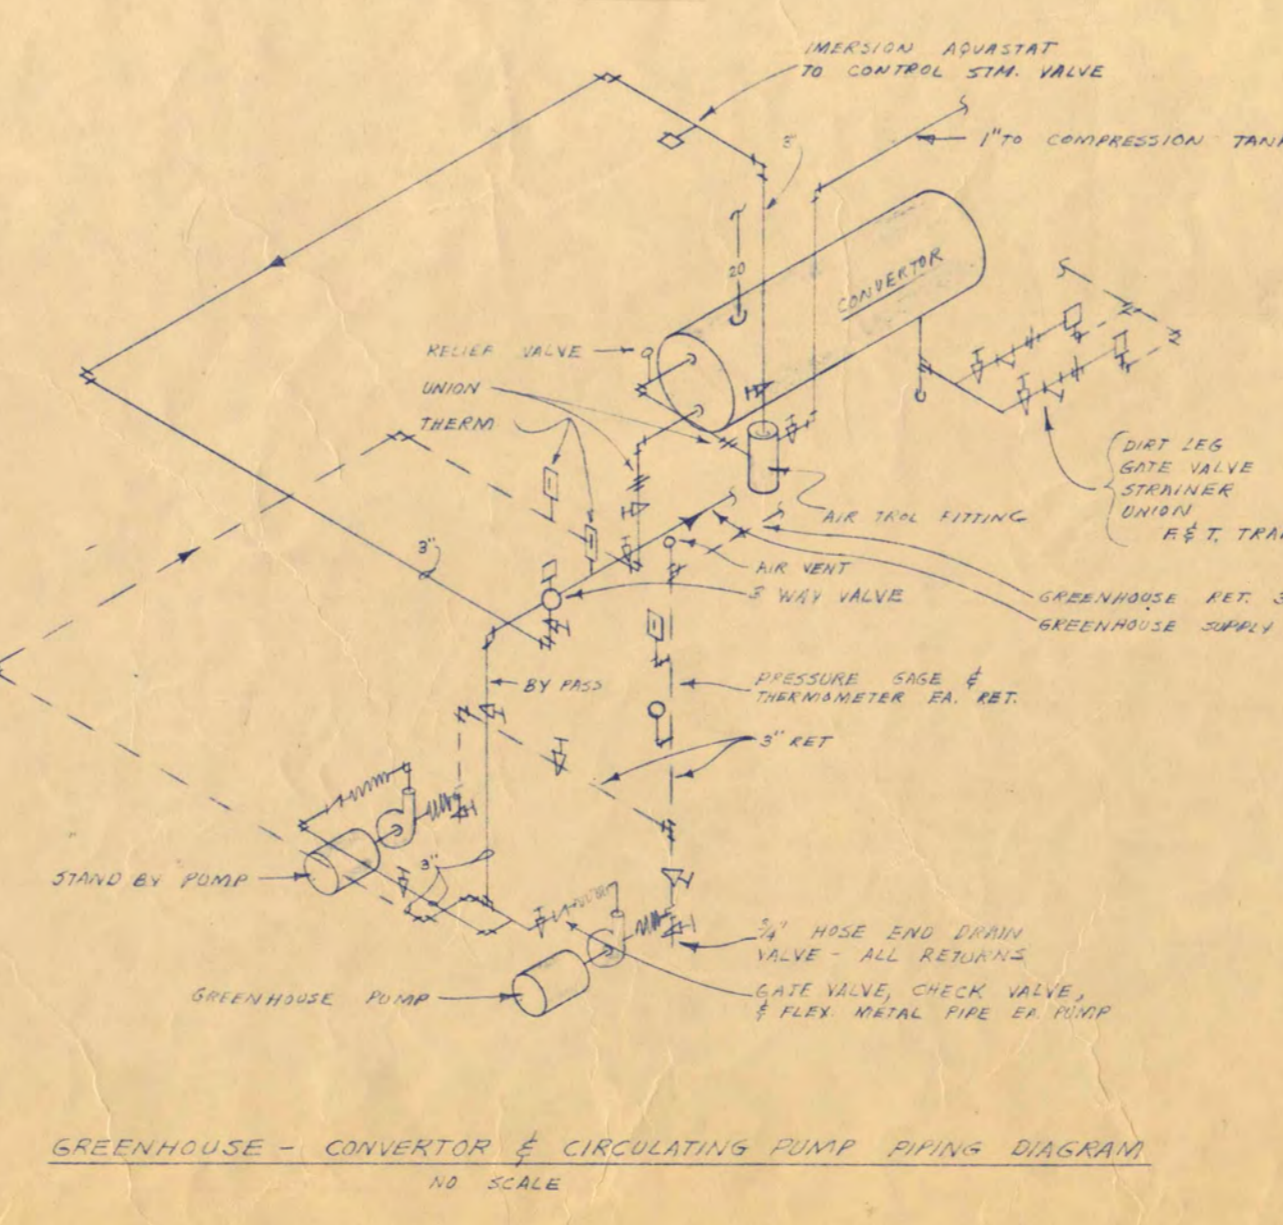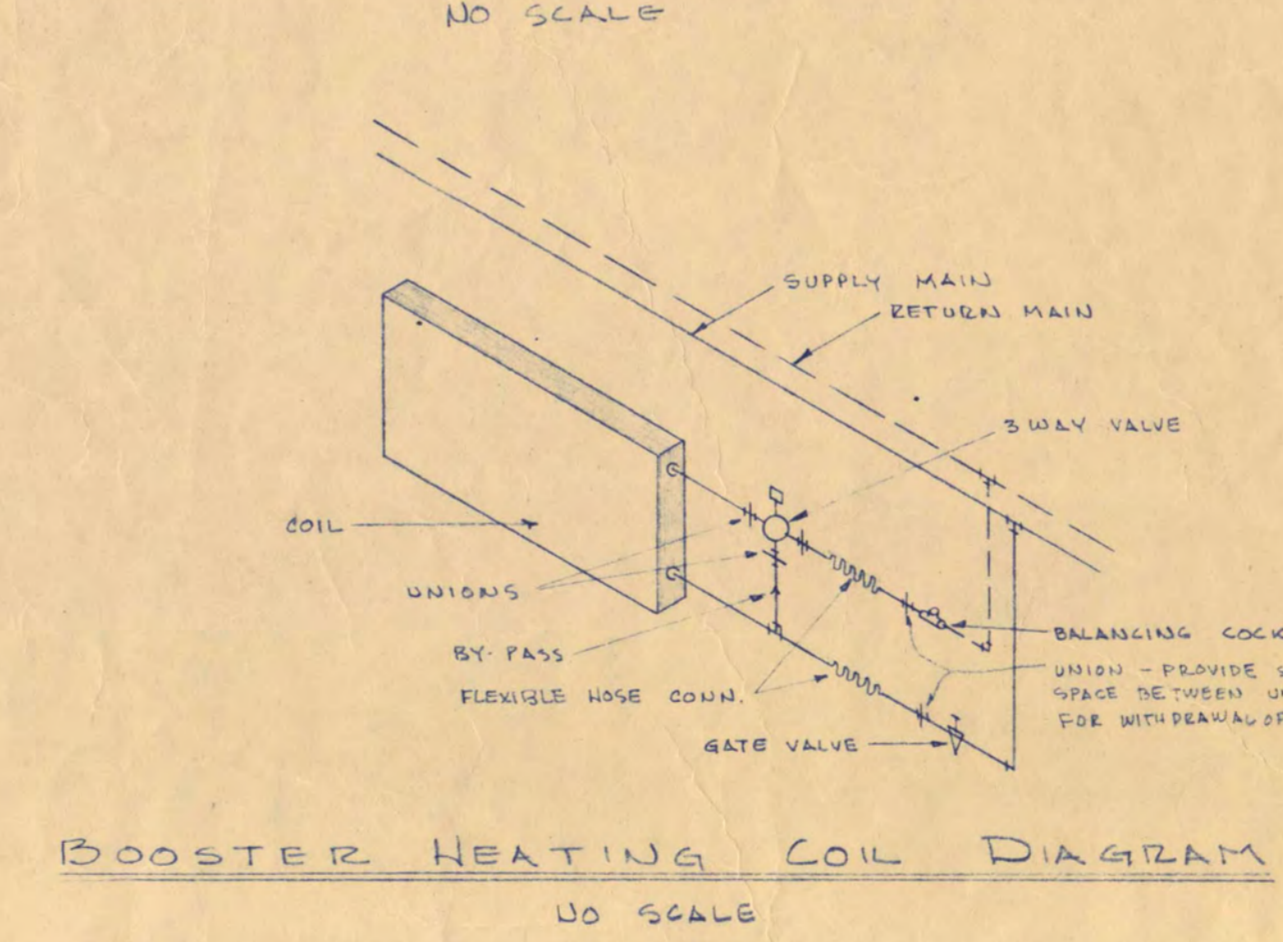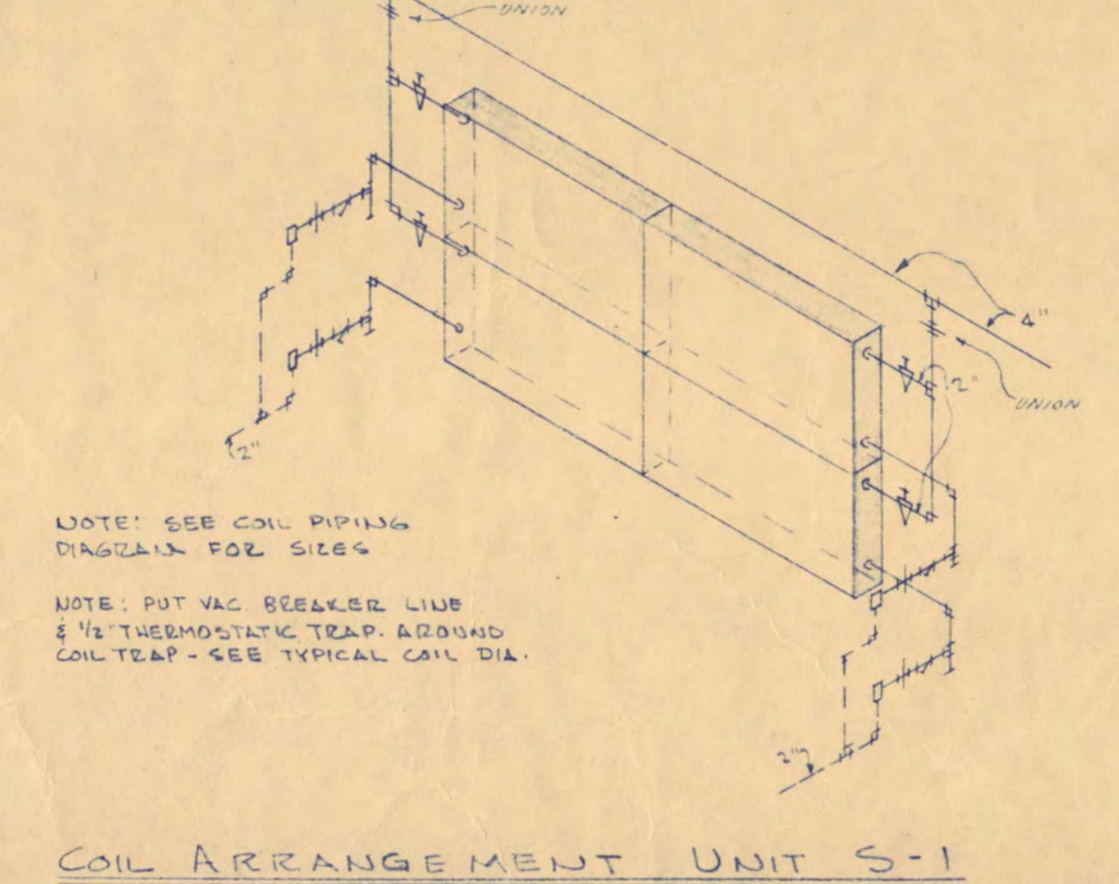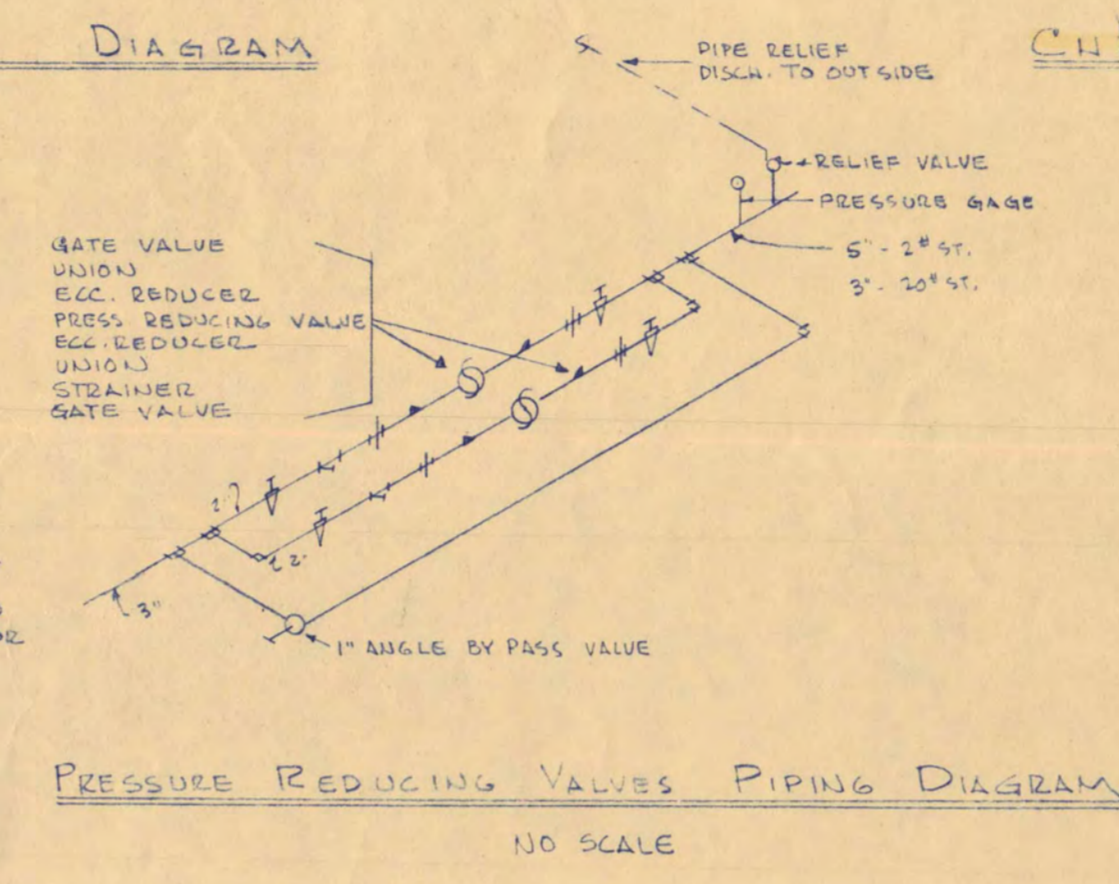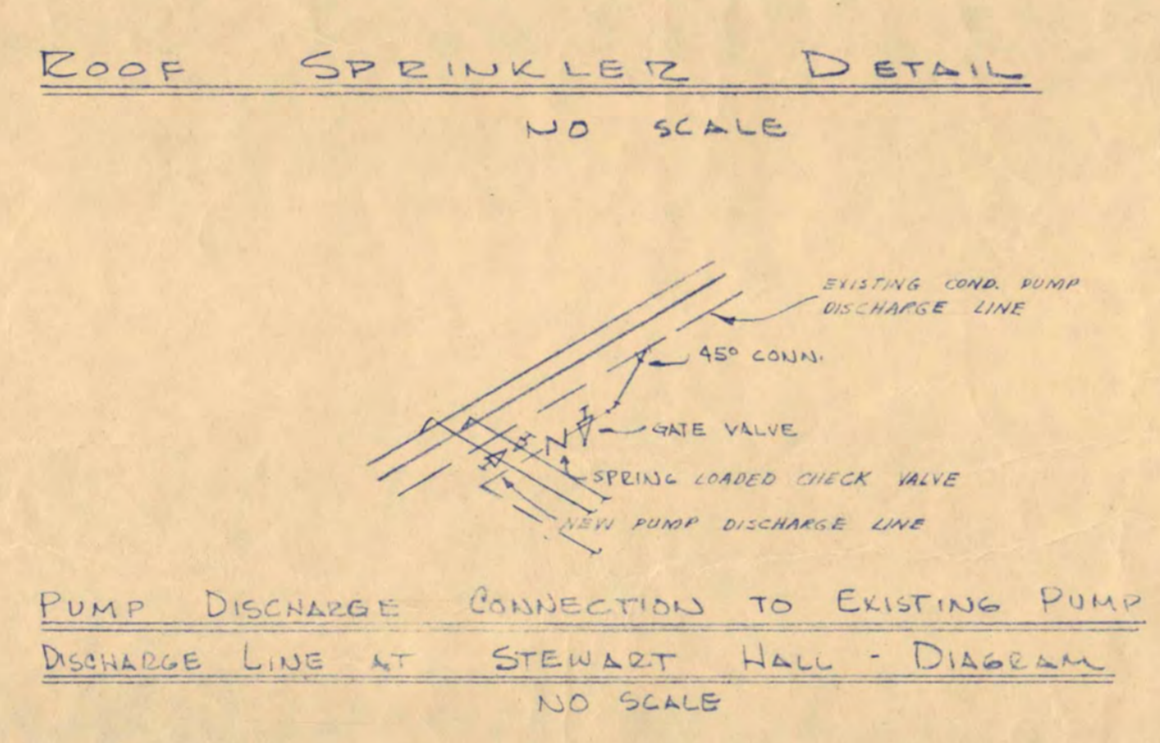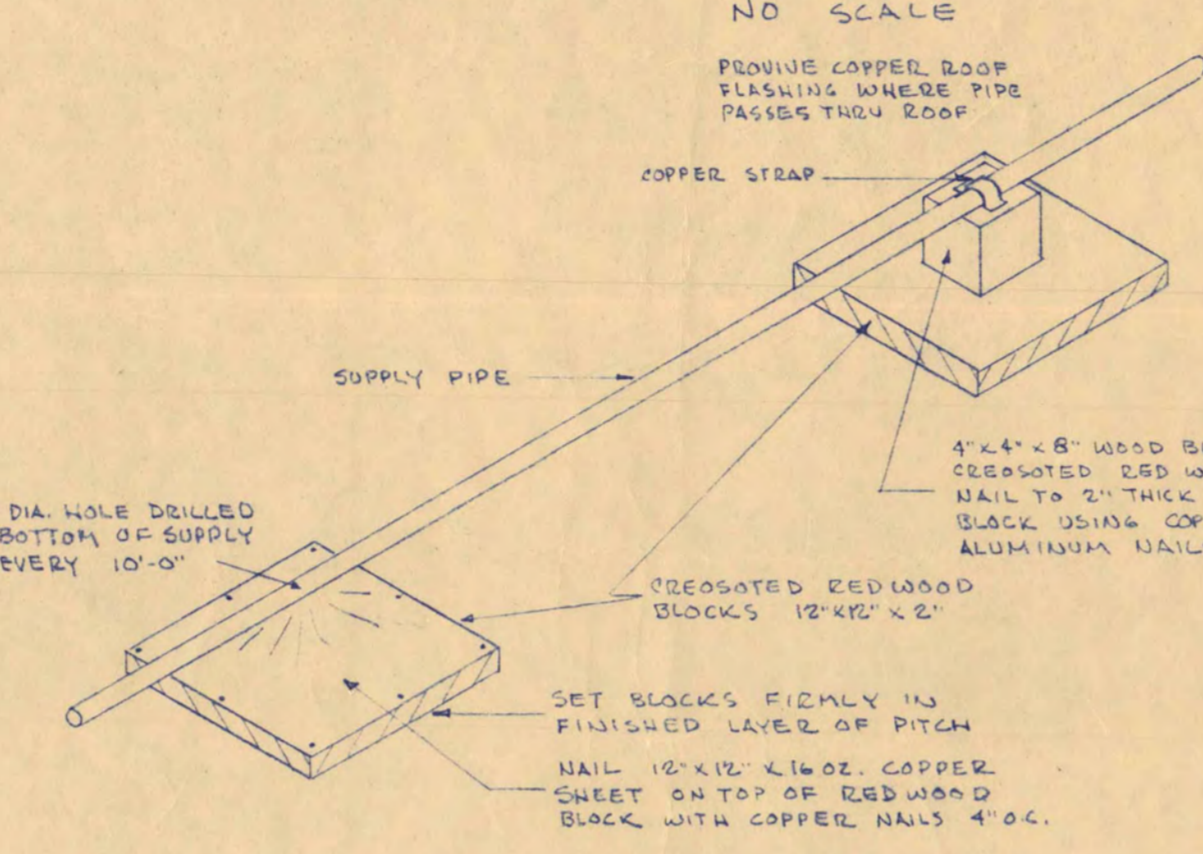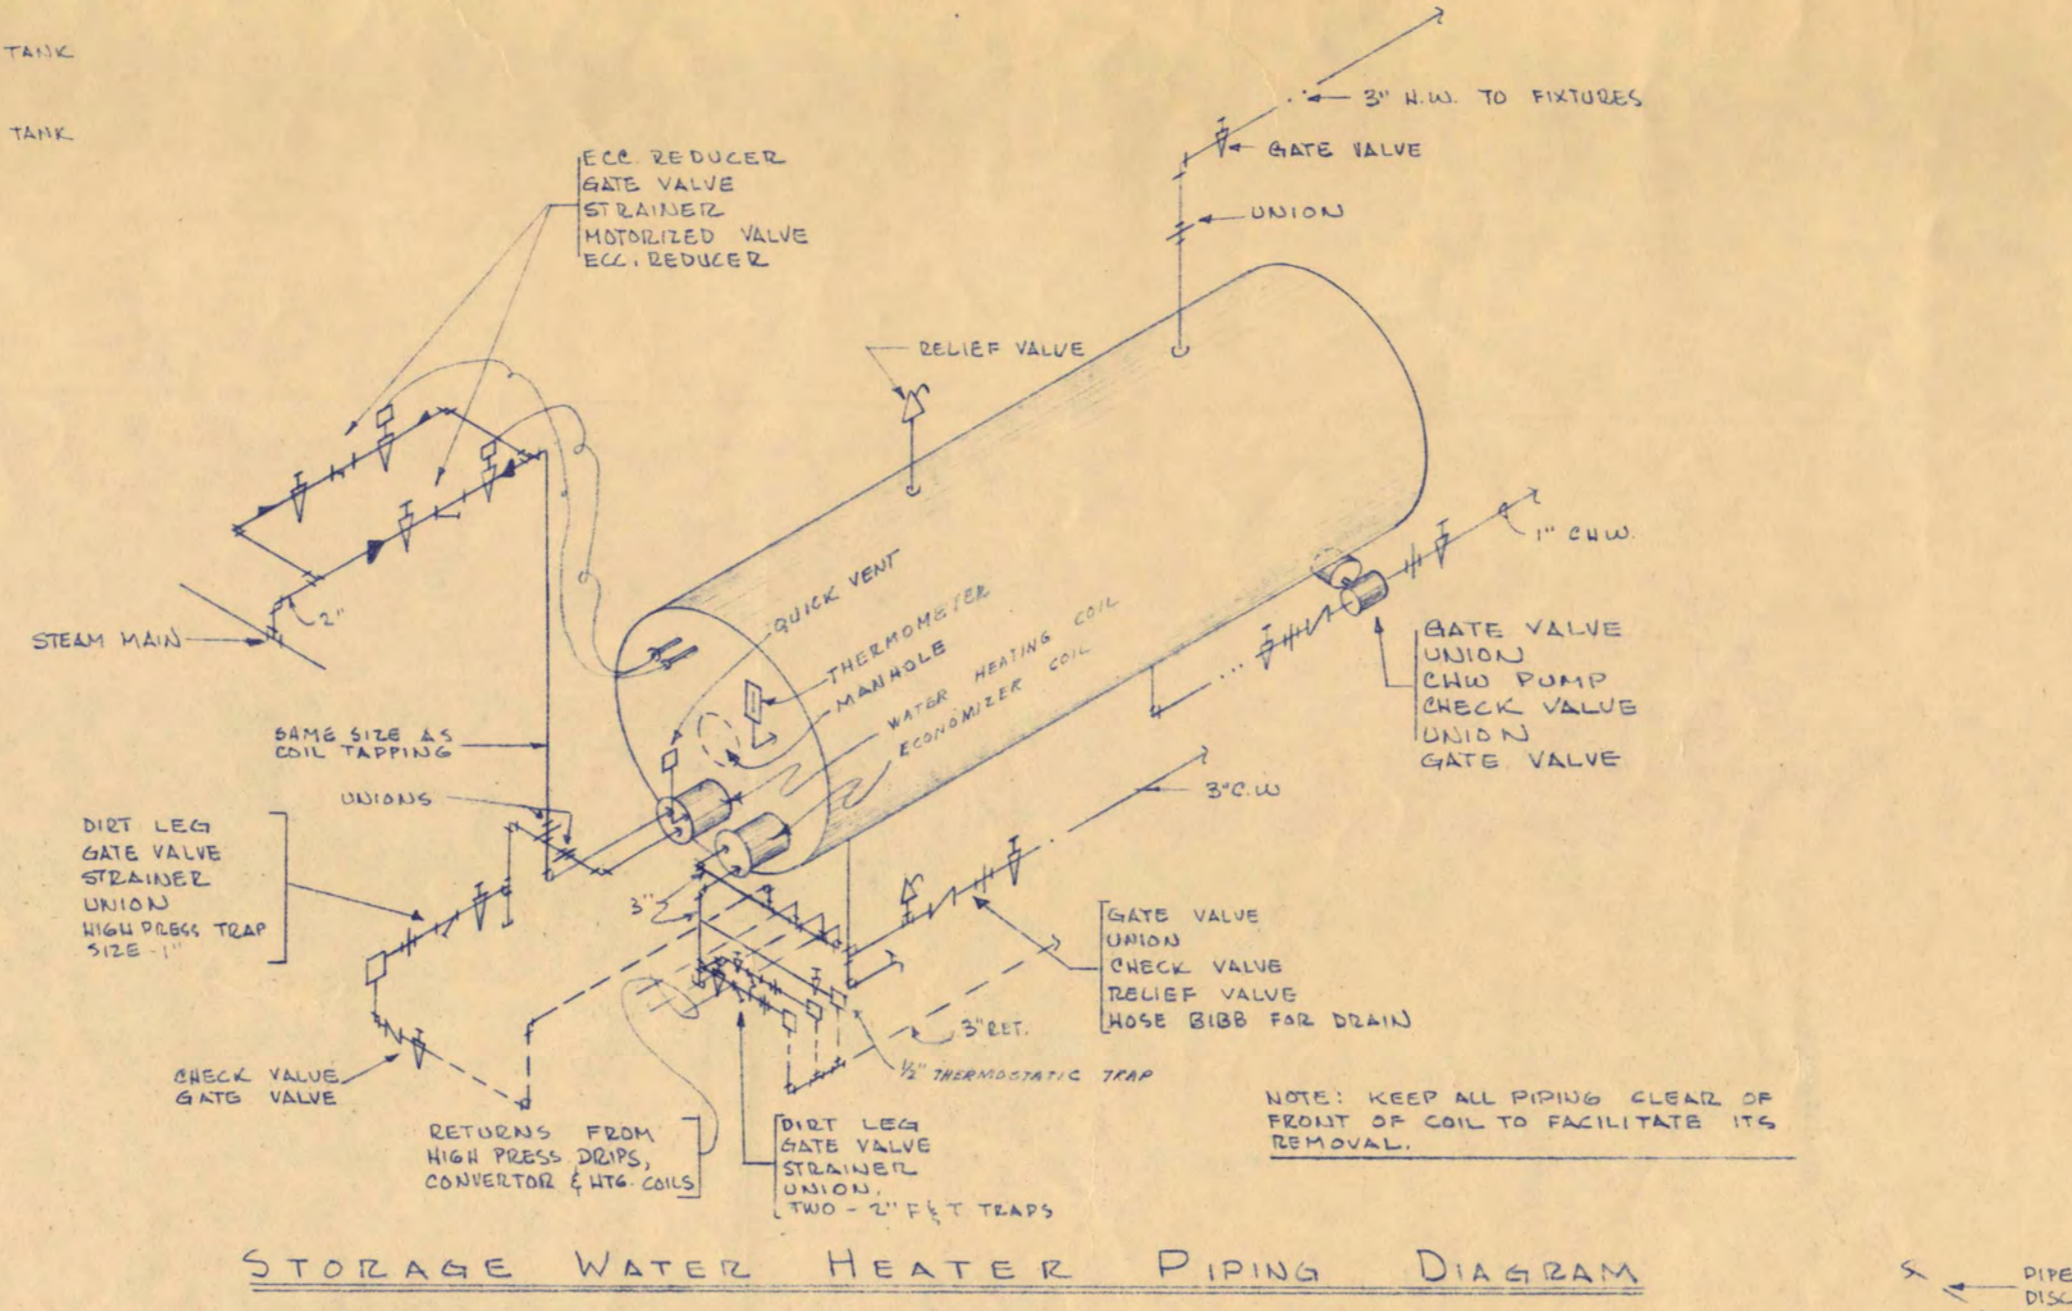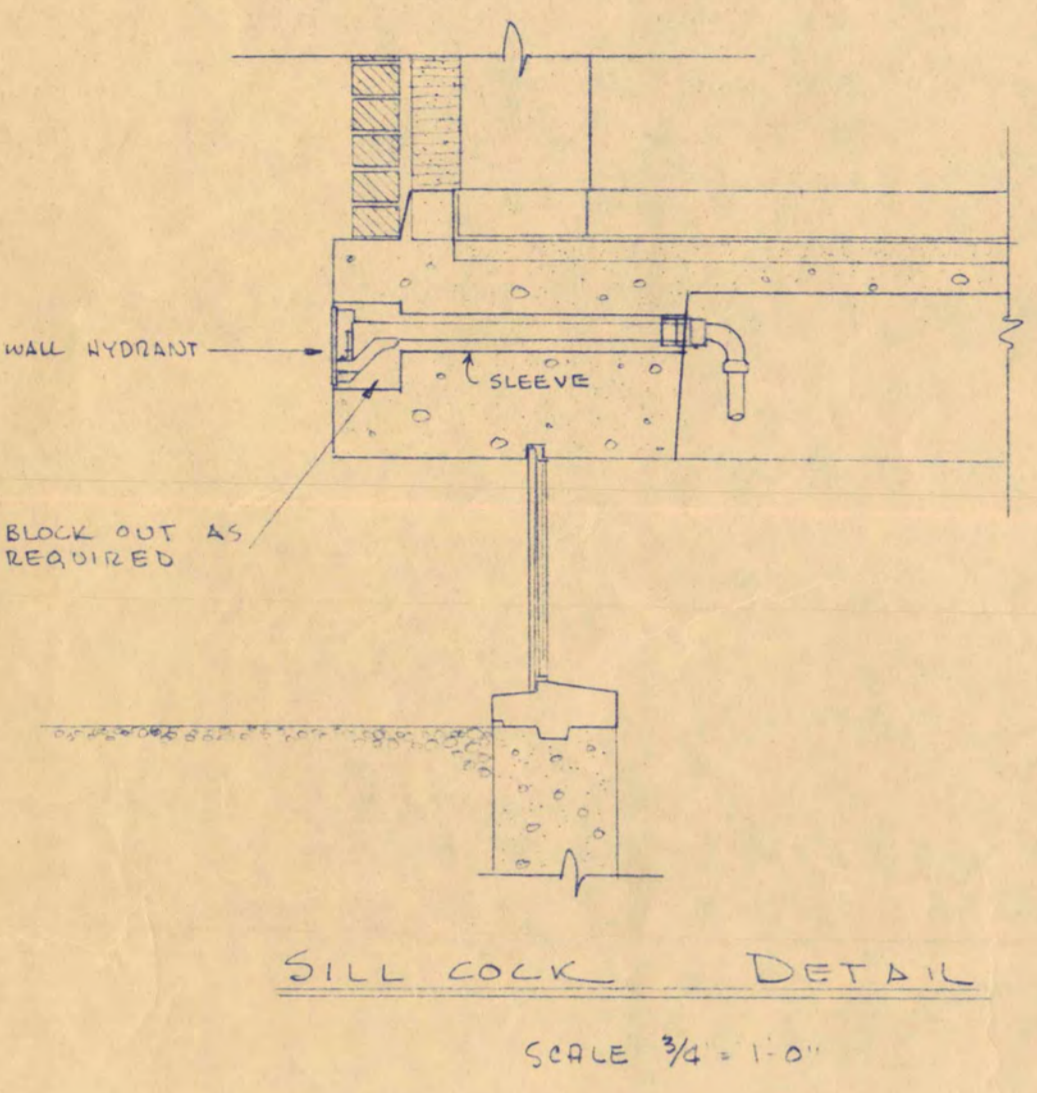

COIL IDENTIFICATION	STEAM - SIZE	TRAP - SIZE	RETURN - SIZE
UNIT S-1	2"	1 1/2"	1 1/2"
UNIT S-2 PREHEAT	1 1/2"	1 1/2"	1 1/2"
UNIT S-3 REHEAT	2"	2"	2"
UNIT C-5	1 1/2"	1 1/2"	1 1/2"
UNIT D-4	1 1/2"	1 1/2"	1 1/2"

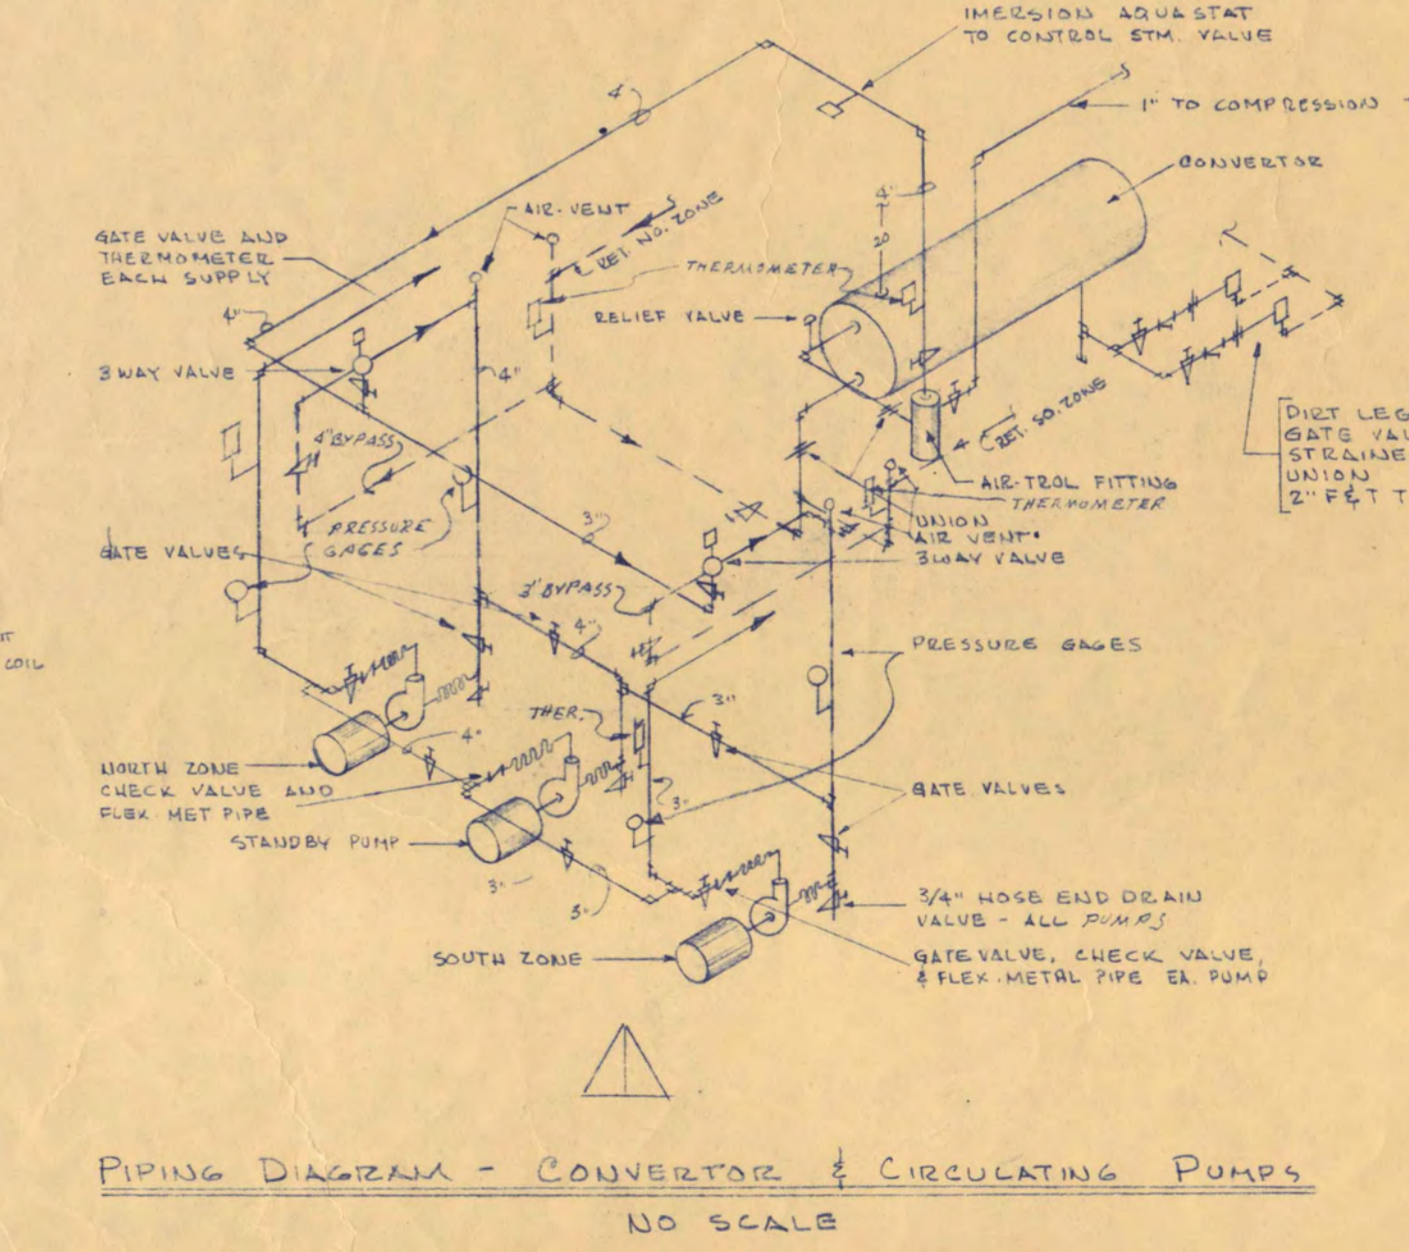

- PLUMBING AND HEATING SYMBOLS**
- SUPPLY MAIN
 - RETURN MAIN
 - RETURN MAIN COVERED UNDERFLOOR
 - GATE VALVE
 - MOTORIZED VALVE
 - TRAP
 - STRAINER
 - UNION
 - CHECK VALVE
 - WASTE, SOIL, OR RAINWATER UNDERFLOOR
 - WASTE, SOIL, OR RAINWATER ON CEILING
 - VENT
 - COLD WATER (C.W.)
 - HOT WATER (H.W.)
 - CIRCULATING HOT WATER (C.H.W.)
 - SILCOCK (S.C.)
 - FLOOR DRAIN (F.D.)
 - CHILLED COLD WATER
 - CIRCULATING CHILLED COLD WATER

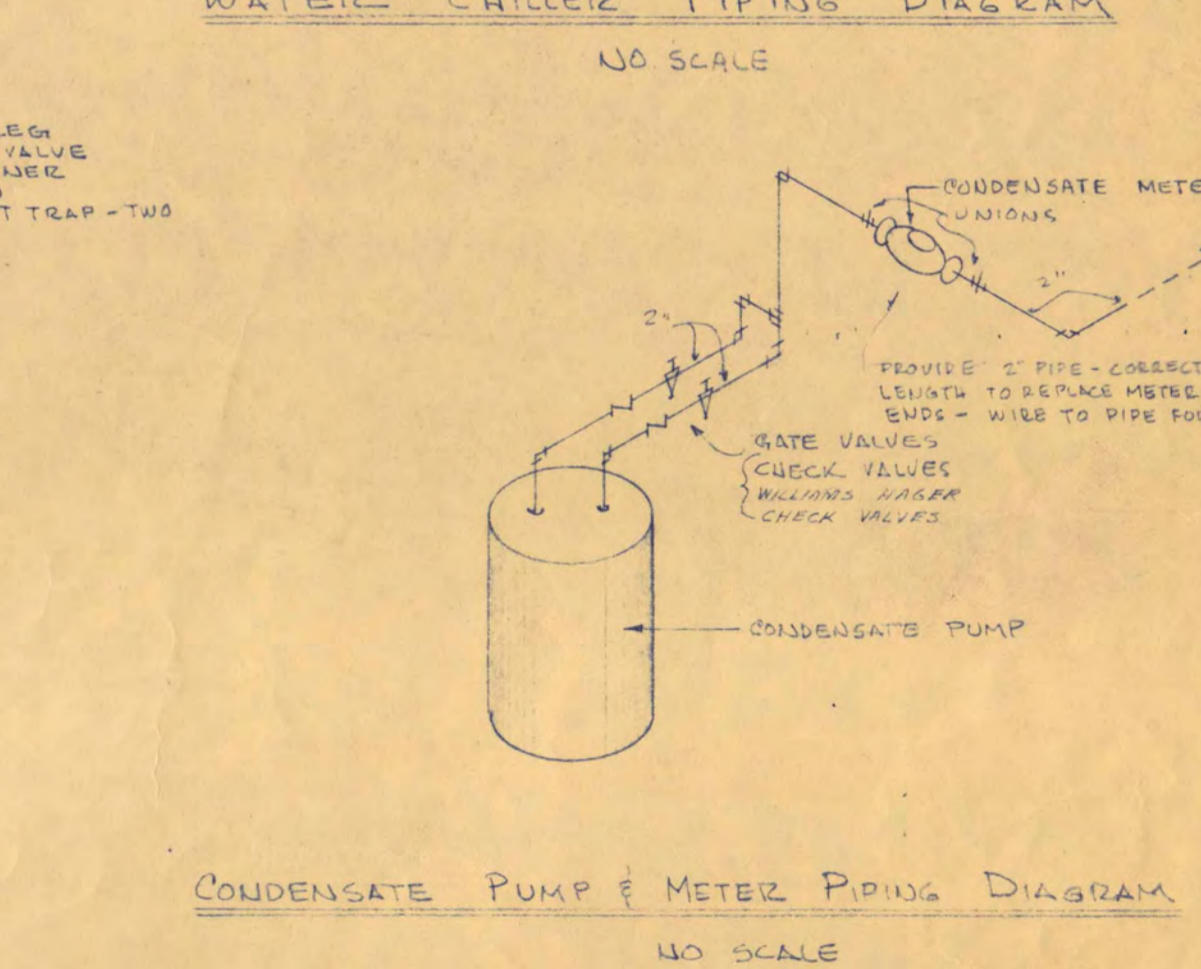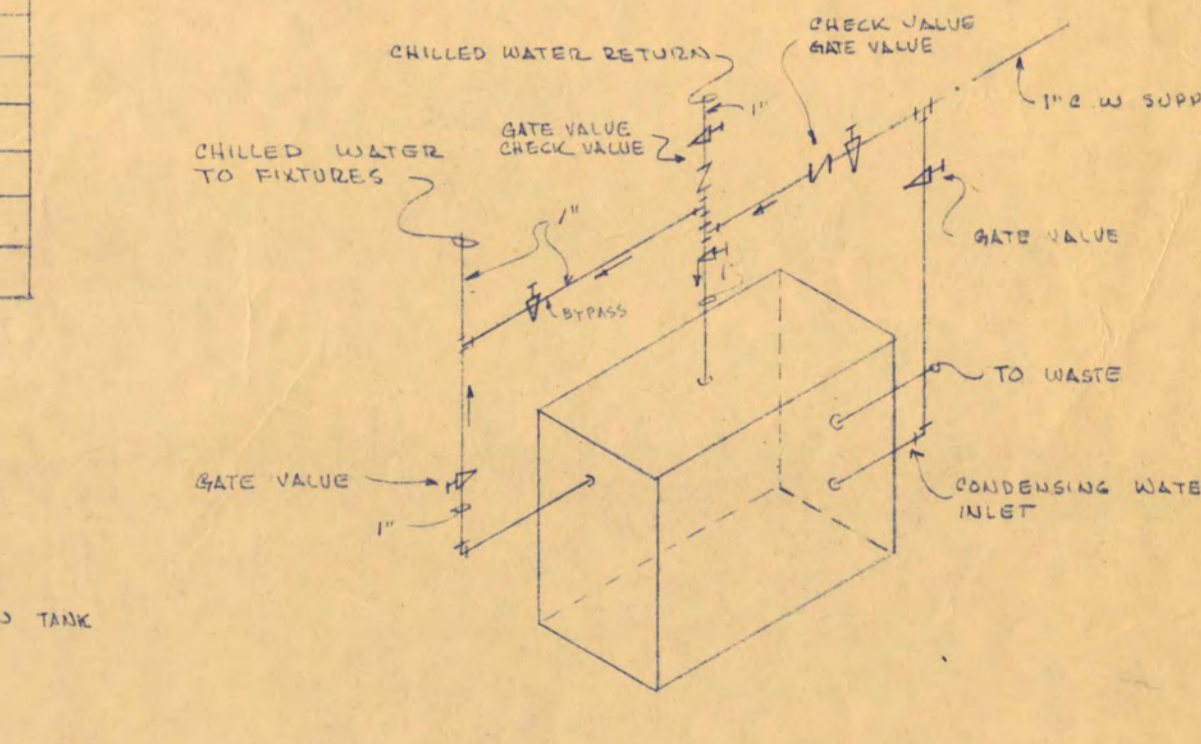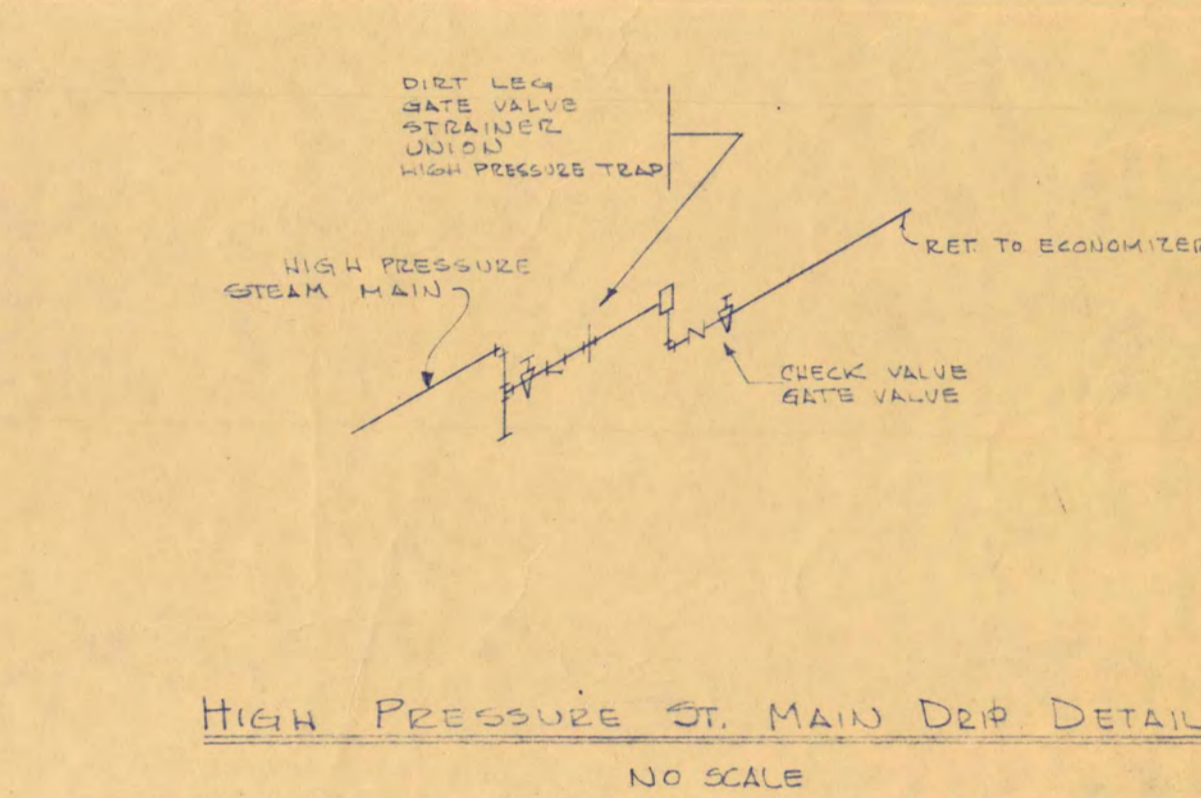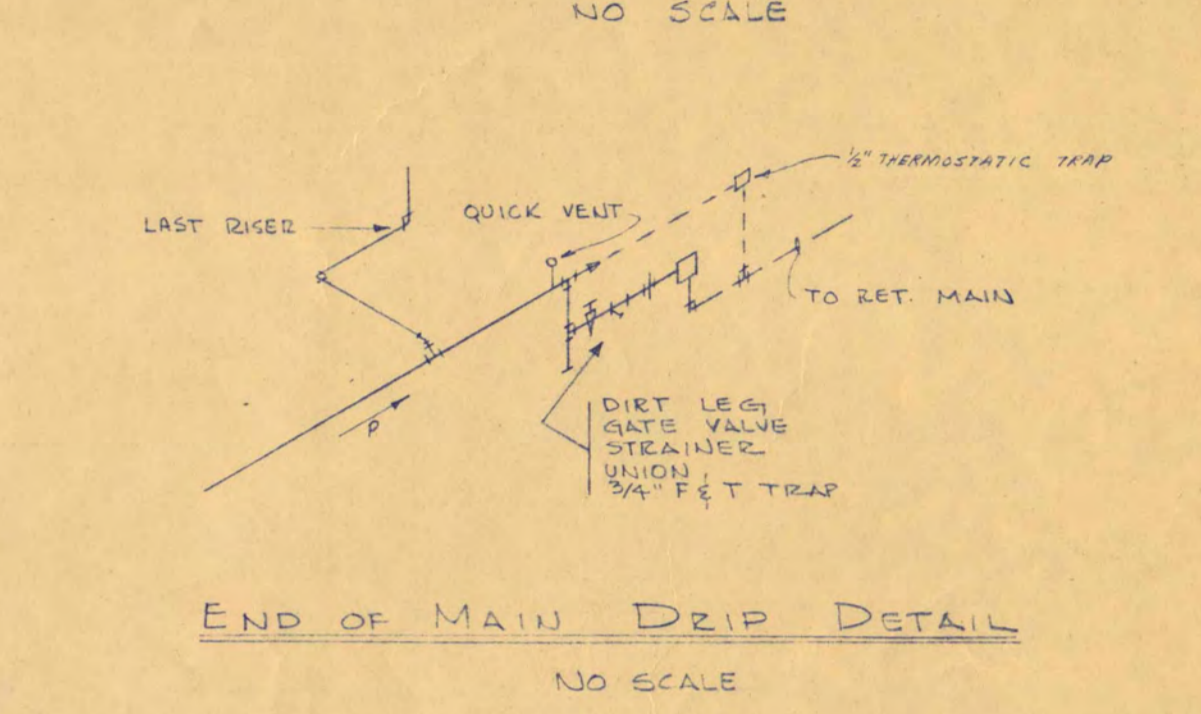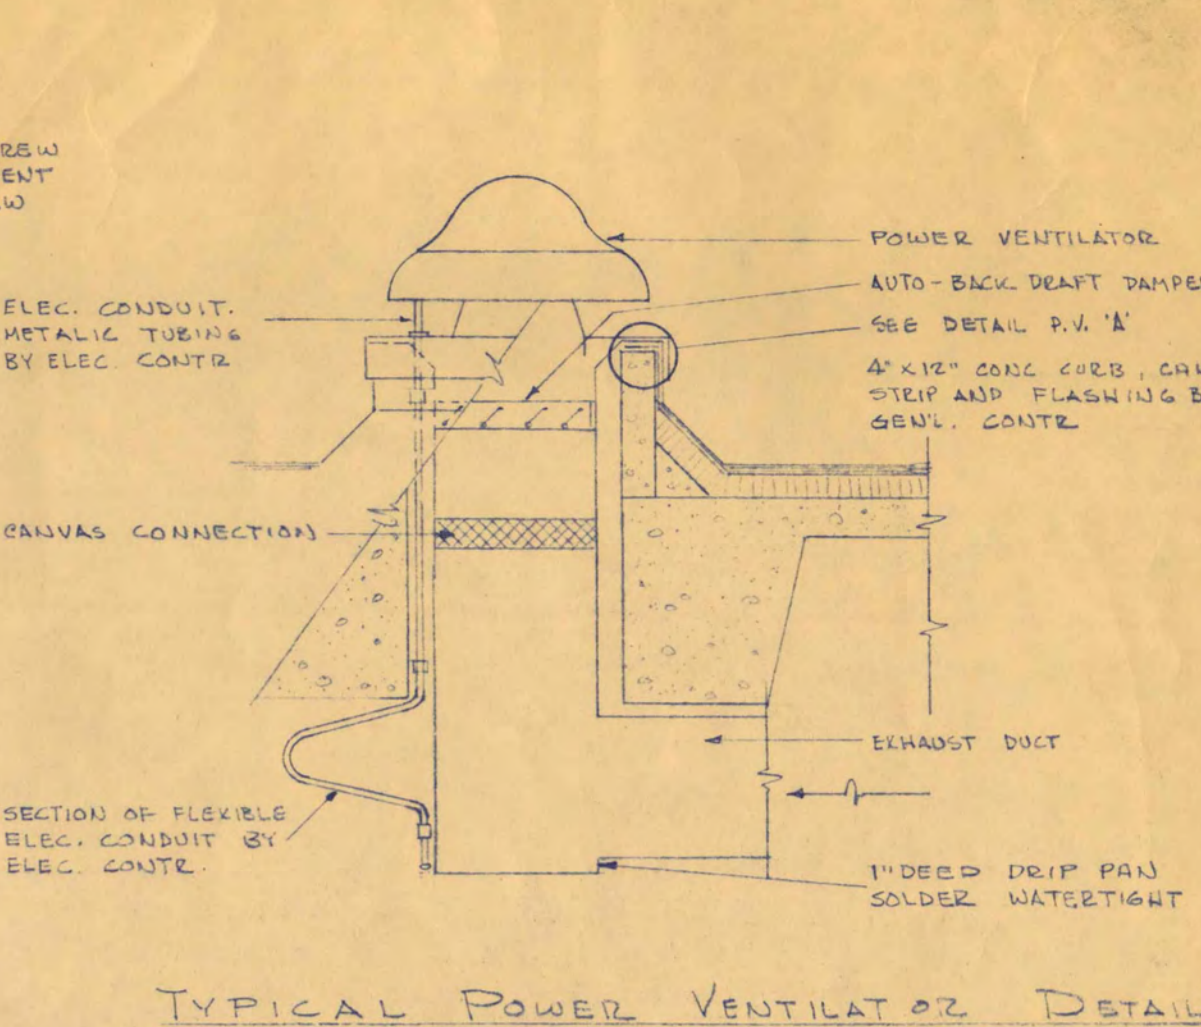

SCIENCE AND MATHEMATICS BUILDING
ST. CLOUD STATE COLLEGE
ST. CLOUD, MINNESOTA

DEPARTMENT OF ADMINISTRATION STATE OF MINNESOTA
ROOM 120 STATE CAPITOL BUILDING ST. PAUL, MINNESOTA
ARCHITECTURAL AND ENGINEERING DIVISION


A.J. NELSON, STATE ARCHITECT

TRAYNOR AND HERMANSON, ARCHITECTS ST. CLOUD, MINN.
BAUMANN AND MOORE, INC. CONSULTING ENGINEERS ST. PAUL, MINN.
JOHNSTON BAUMANN CO. STRUCTURAL ENGINEERS MINNEAPOLIS, MINN.


DATE: 7-18-58
REVISED: 8/7/58
DRAWN BY: G.V.G.
CHECKED BY: G.V.G.

APPROVED BY: PRESIDENT ST. CLOUD STATE COLLEGE
APPROVED BY: STATE COLLEGE BOARD
APPROVED BY: COMMISSIONER OF ADMINISTRATION AN AUTHORIZED SIGNATURE


SHEET NO. M-7 OF 7
STATE PROJECT NUMBER 2600

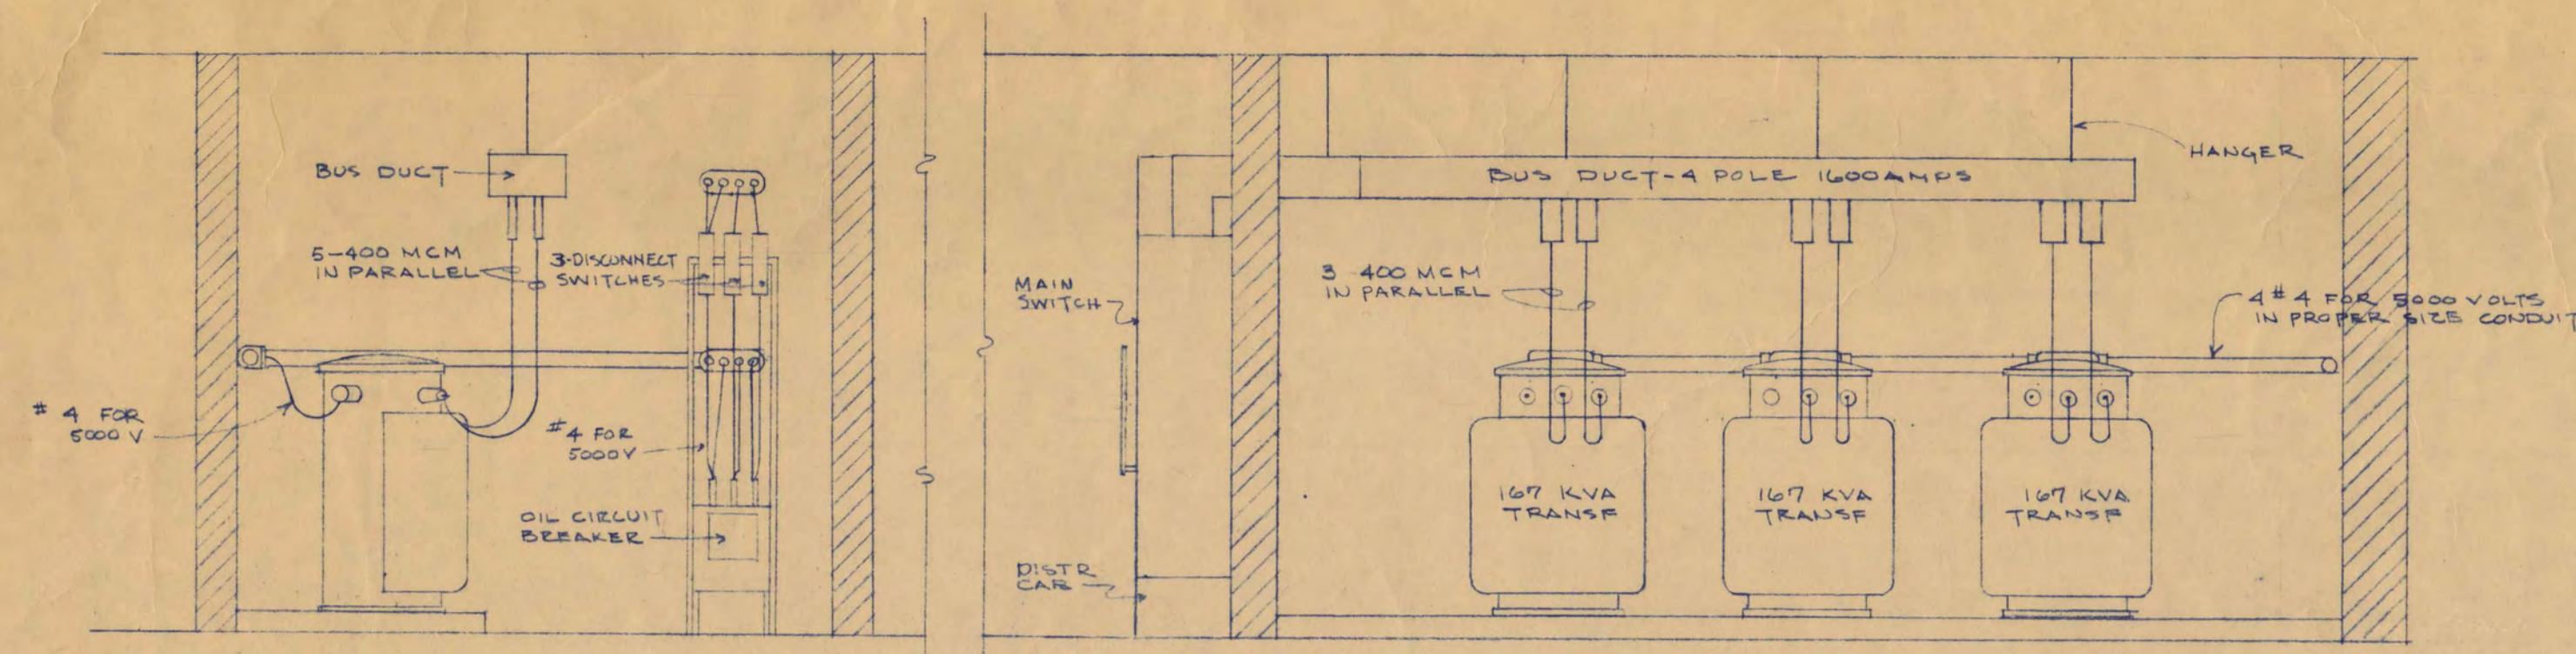

SECTION 1
SECTION 2
ELEVATION OF TRANSFORMER VAULT
SCALE 3/8" = 1'-0"

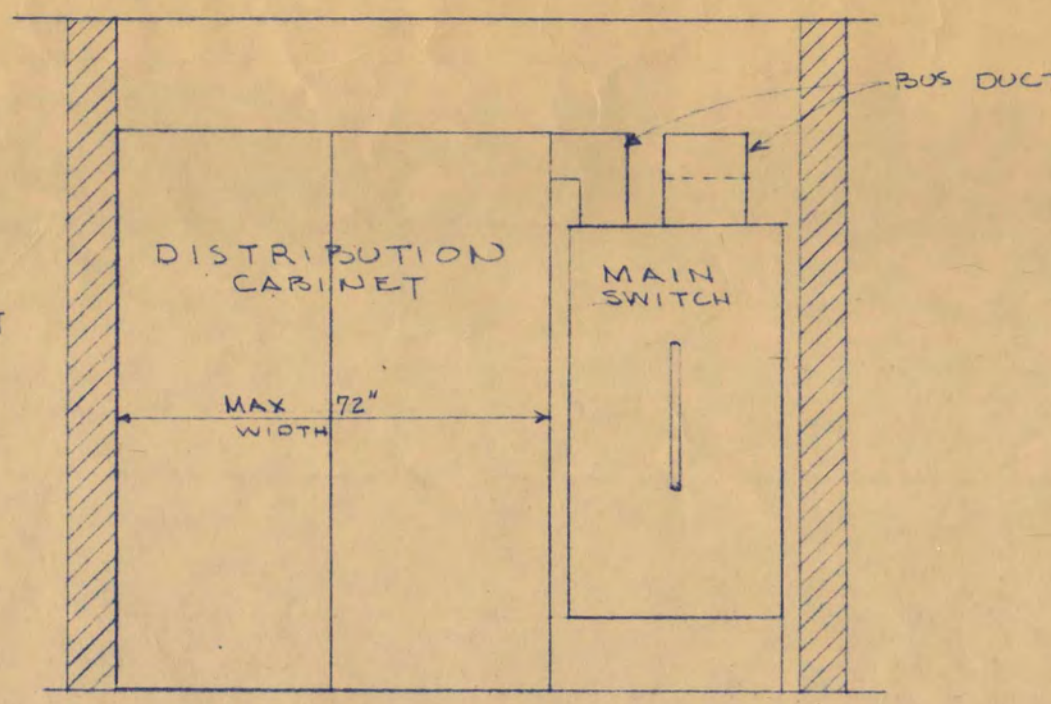


SECTION 3

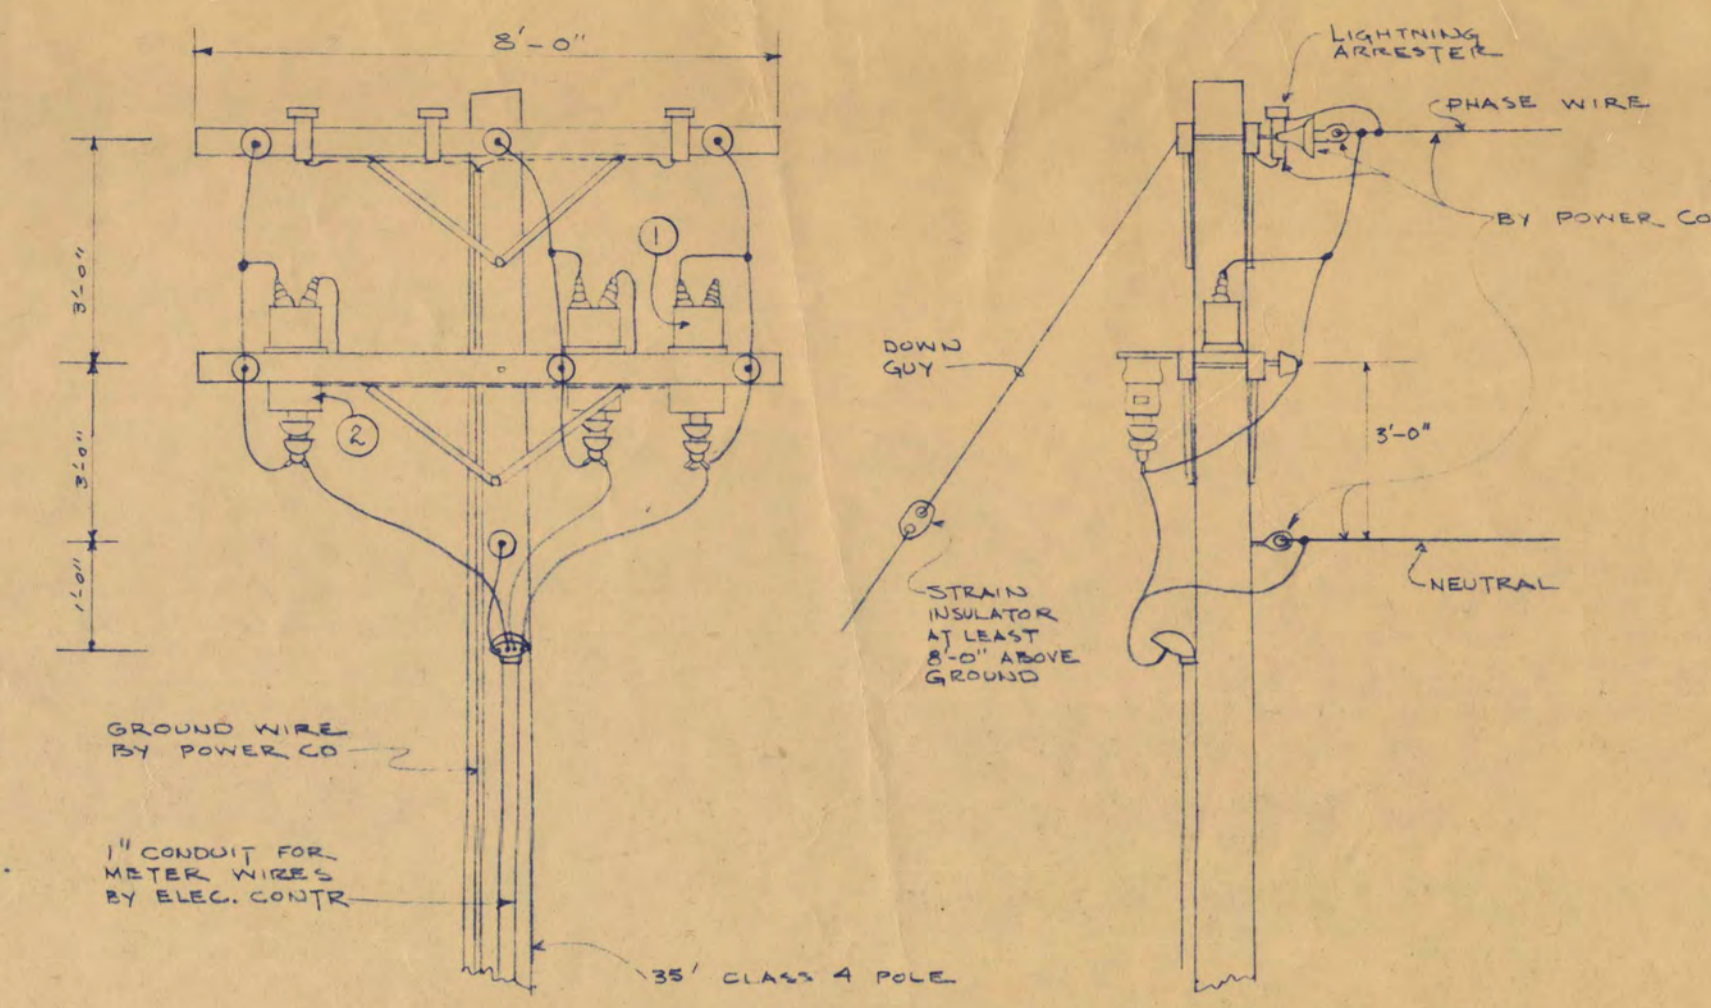


- ① POTENTIAL TRANSFORMER
 - ② CURRENT TRANSFORMER
- ALL ABOVE BY ELECTRICAL CONTRACTOR EXCEPT AS OTHER WIRE LISTED OR SPECIFIED

DETAIL OF METER POLE TOP
NO SCALE

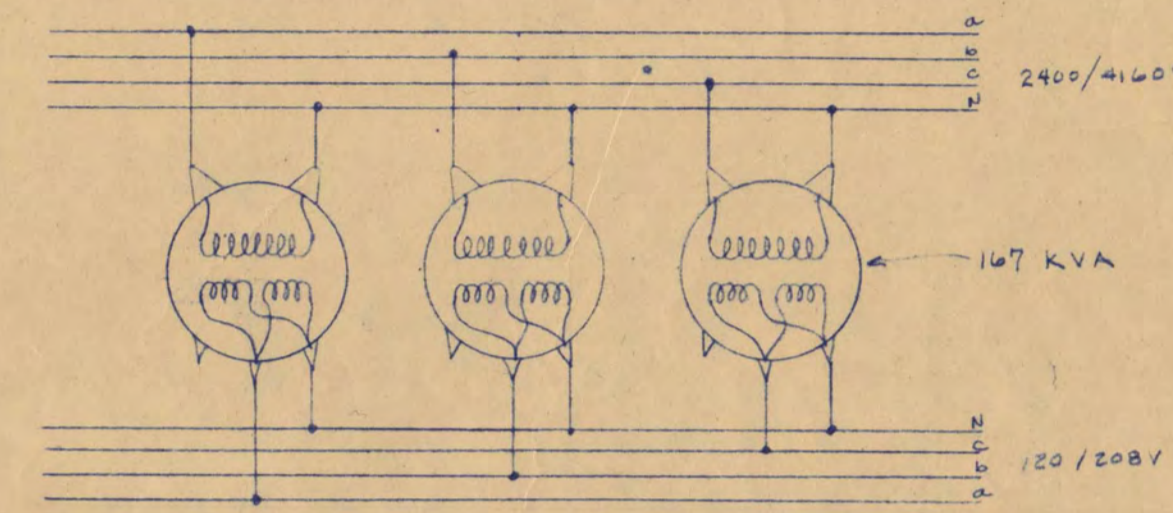

TRANSFORMER CONNECTIONS
NO SCALE

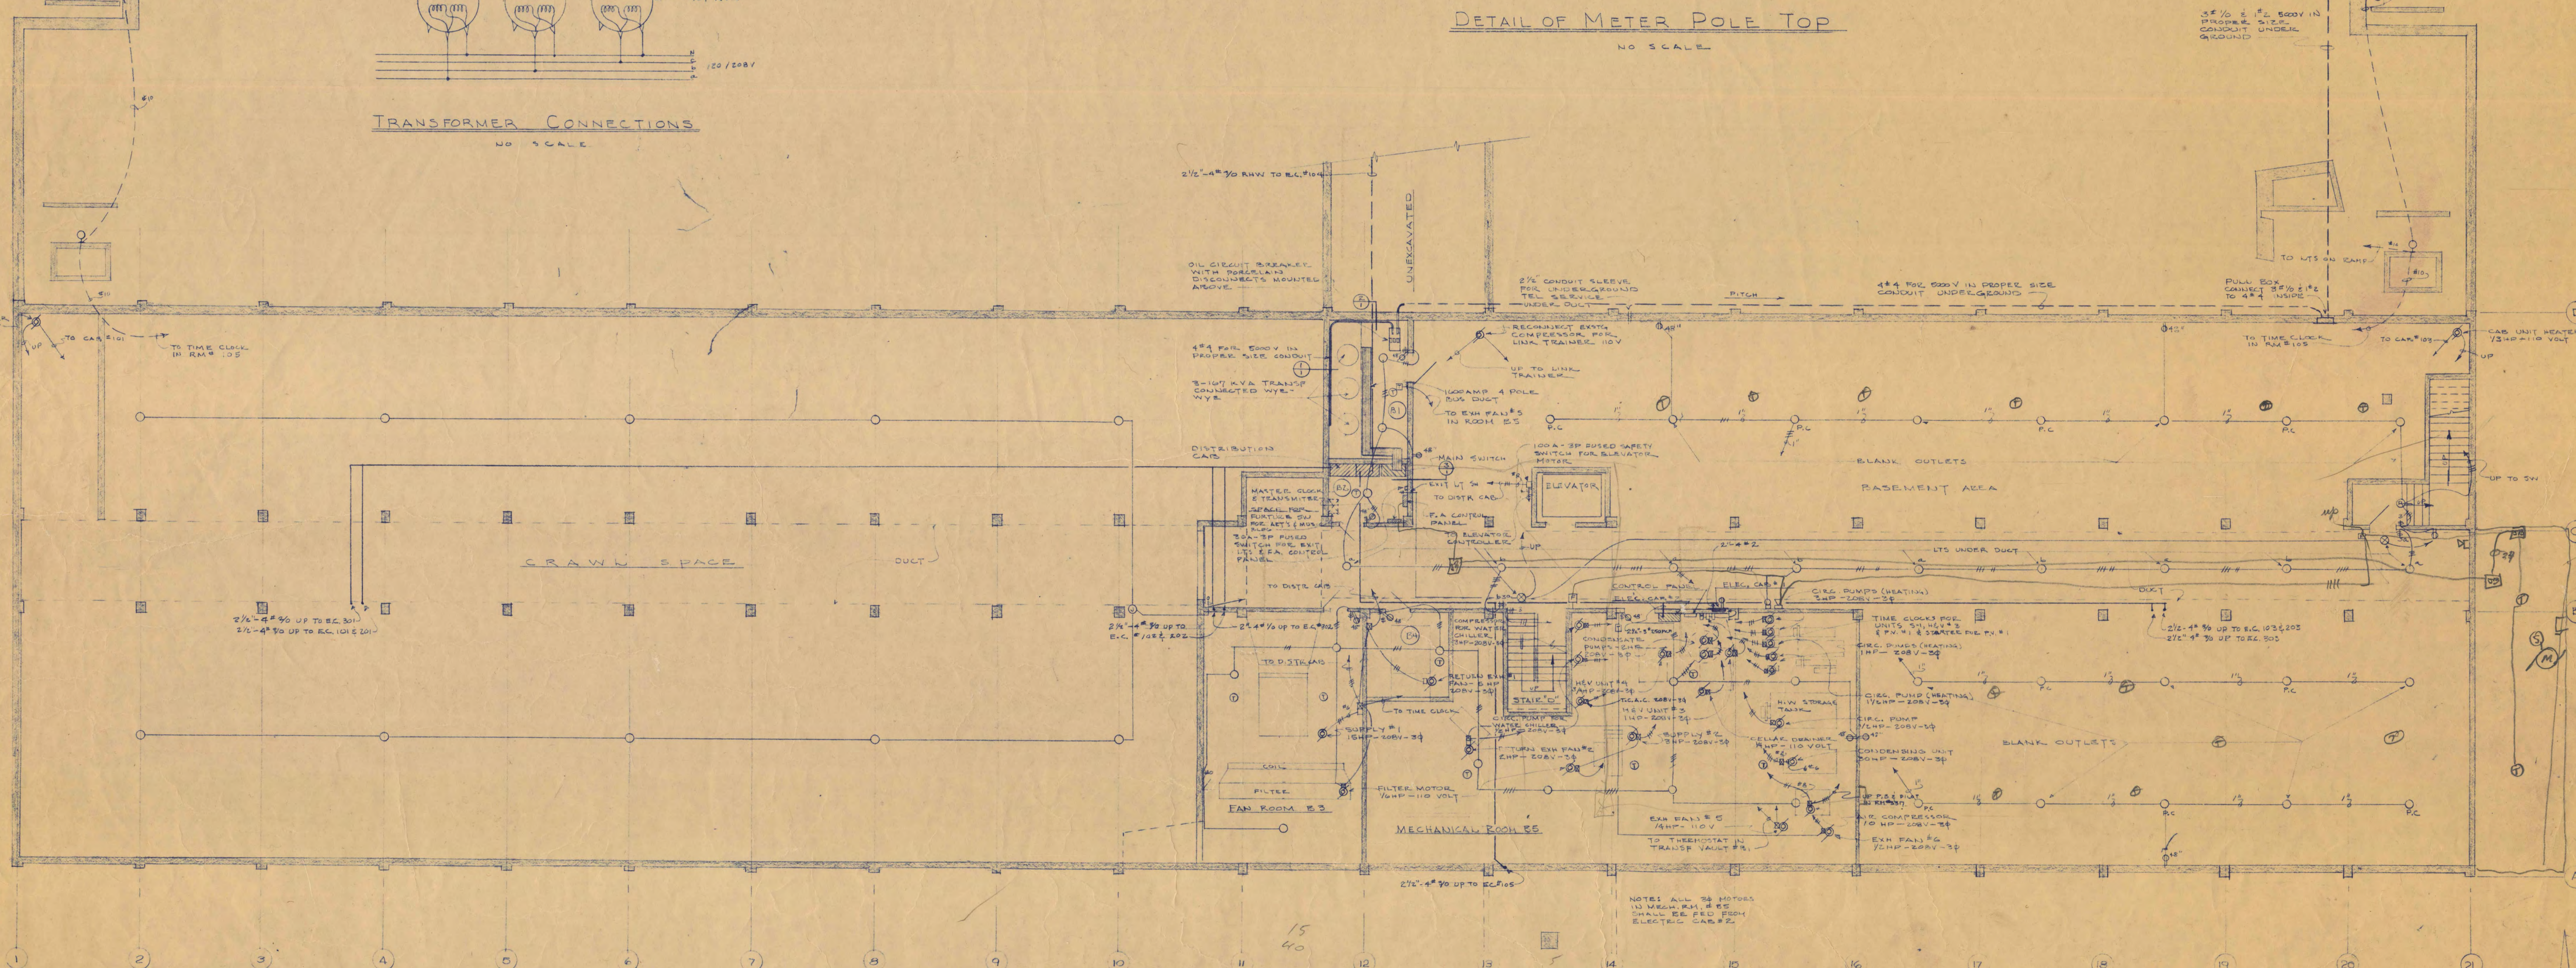

BASEMENT ELECTRICAL PLAN
SCALE 1/8" = 1'-0"

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AJ. NELSON, STATE ARCHITECT

TRAYNOR AND HERMANSON, ARCHITECTS ST. CLOUD, MINN.
GAUBMAN AND MOORE, INC. CONSULTING ENGINEERS ST. PAUL, MINN.
JOHNSON, RAHLMAN CO. STRUCTURAL ENGINEERS MINNEAPOLIS, MINN.

DATE 7-15-58
REVISED
DRAWN BY
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SHEET NO. E-1
OF 2
STATE PROJECT NUMBER 2600

I hereby certify that this plan, specification, or report was prepared by me or under my direct supervision and that I am a duly Registered Professional Engineer under the laws of the State of Minnesota.

Date 7-18-58 Re. No. 1787